

BOSWELL

Boswell Capital Improvement Projects

Verona Township Council Meeting


A CENTURY OF EXCELLENCE



1924 ~ 2024

Engineered For Life



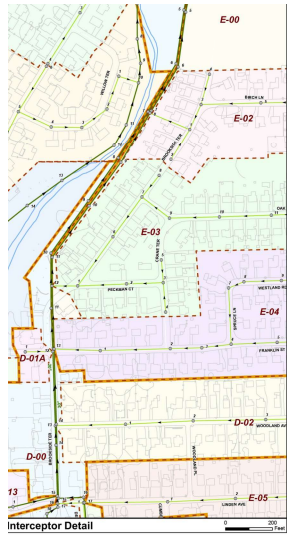


NORTH CALDWELL
BOROUGH

CEDAR GROVE
TOWNSHIP

ESSEX FELLS
TOWNSHIP

WEST ORANGE
TOWNSHIP

GRAPHIC SCALE

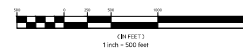

REFERENCE NOTE:

TOPOGRAPHY AND SEWER LOCATIONS SHOWN ON THIS MAP AS TAKEN FROM A MAP
PREPARED BY HATCH/MOTT MAC DONALD FOR THE TOWNSHIP OF VERONA.

Verona Wastewater
Treatment Plant

See Interceptor Detail

FLows TO WEST
ORANGE TOWNSHIP

LEGEND

- DEFECTIVE OR MISSING CLEAN
OUT CAPS
- RESIDENTIAL DETECTED SMOKE
LOCATION
- ILLEGAL RESIDENTIAL CONNECTIONS
AND DEFECTIVE LATERALS
- TOWNSHIP DETECTED SMOKE
LOCATIONS

NO.	DATE	DESCRIPTION	REMOVED BY	CHECKED BY

GISELLE DIAZ

PROFESSIONAL ENGINEER N.J. LIC. 44832


BOSWELL

BOSSWELL ENGINEERING, INC.
1000 ROUTE 100, SUITE 100
VERONA, NJ 07066
TEL: 973.261.1000
FAX: 973.261.1001
WWW.BOSWELL-ENG.COM

SANITARY SEWER STUDY

SMOKE TESTING RESULTS MAP

TOWNSHIP OF VERONA ESSEX COUNTY NEW JERSEY			
SURVEYED BY: C.B.	DESIGNED BY: C.B.	DATE: NOV. 2024	JOB NO.: E
DRAWN BY: G.D.	CHECKED BY: G.D.	SCALE: 1"=500'	SHEET: 1 OF 1

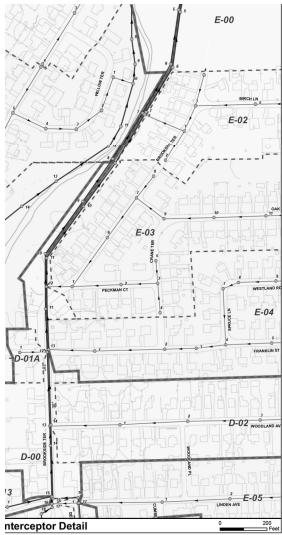

NORTH CALDWELL
BOROUGH



Verona Wastewater
Treatment Plant

See Interceptor Detail


CEDAR GROVE
TOWNSHIP

ESSEX FELLS
TOWNSHIP

WEST ORANGE
TOWNSHIP

FLows TO WEST
ORANGE TOWNSHIP

GRAPHIC SCALE

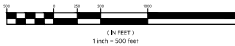


LEGEND



NO. DATE DESCRIPTION REVISION BY				
GISELLE DIAZ				
PROFESSIONAL ENGINEER N.J. LIC. 44832				
BOSWELL				
SANITARY SEWER STUDY				
SANITARY SEWER PHASE MAP				
TOWNSHIP OF VERONA ESSEX COUNTY NEW JERSEY				
SURVEYED BY: C.B.	DESIGNED BY: C.B.	DATE: NOV 2024	JOB NO.: E	
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STATE OF NEW JERSEY

BANK STABILIZATION ALONG THE PECKMAN RIVER

BLOCK 1703 LOTS 54, 55, 56, 59, 60

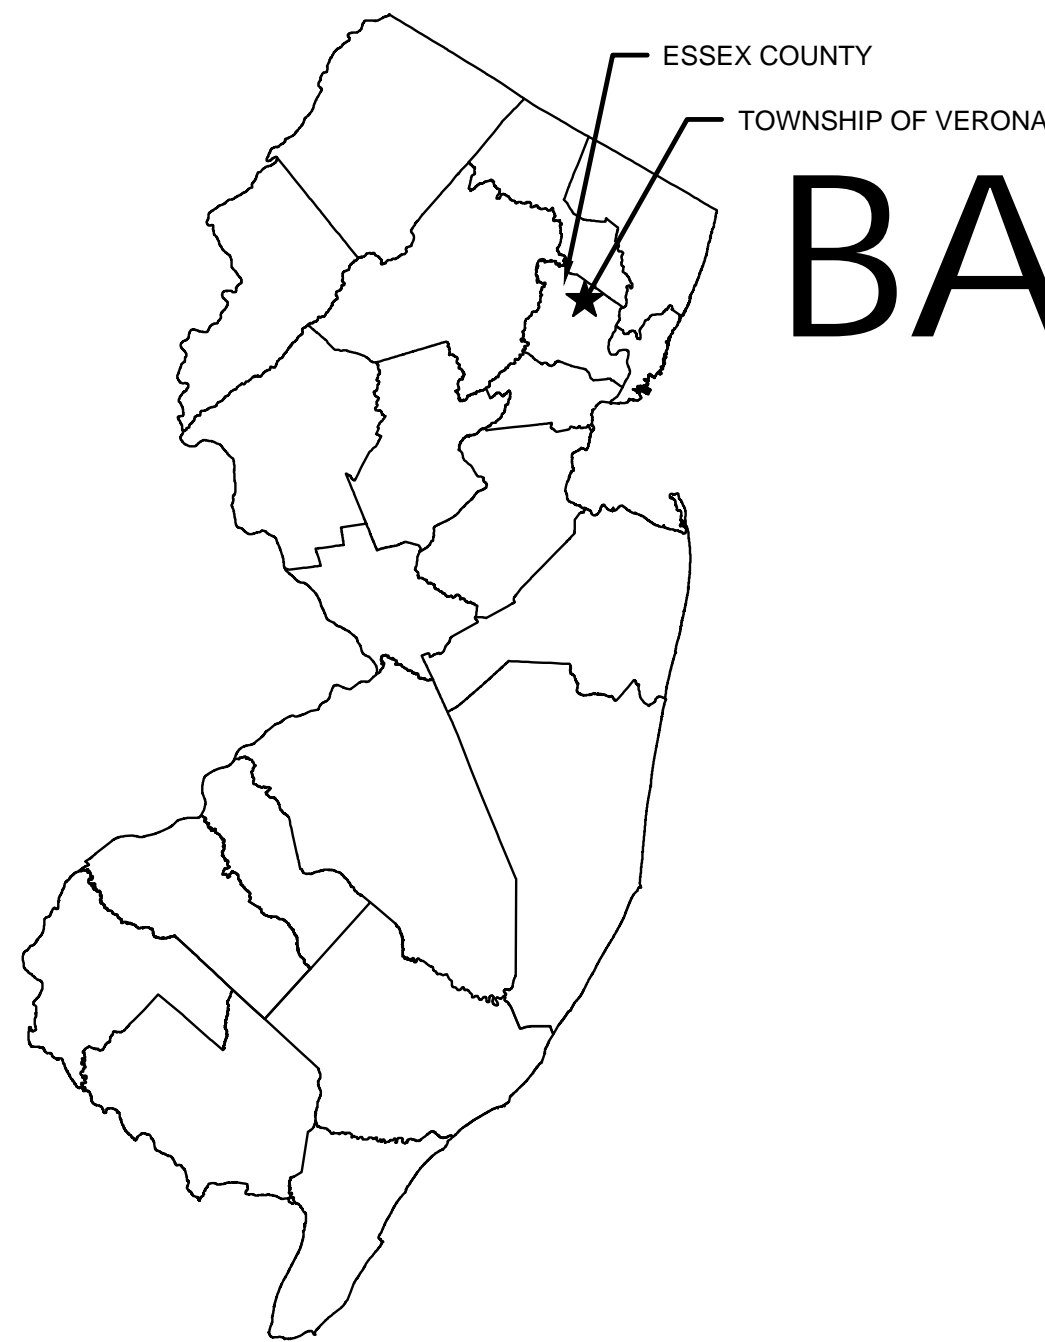TOWNSHIP OF VERONA

Essex County, New Jersey

TOWNSHIP OF VERONA

MAYOR
CHRISTOPHER TAMBURRO

COUNCIL MEMBERS
JACK MCEVOY
CHRISTINE MCGRATH
CYNTHIA HOLLAND
ALEX ROMAN

TOWNSHIP MANAGER
JOSEPH D'ARCO


TOWNSHIP CLERK
JENNIFER KIERNAN

TOWNSHIP ATTORNEY
BRIAN J. ALOIA, ESQ

TOWNSHIP ENGINEER
BOSWELL ENGINEERING

PUBLIC UTILITIES LIST

PUBLIC UTILITIES LIST	
CABLE	COMCAST
ELECTRICITY	PUBLIC SERVICE ELECTRIC & GAS COMPANY
GAS	PUBLIC SERVICE ELECTRIC & GAS COMPANY
TELEPHONE	VERIZON
WATER	MONTCLAIR WATER DEPARTMENT

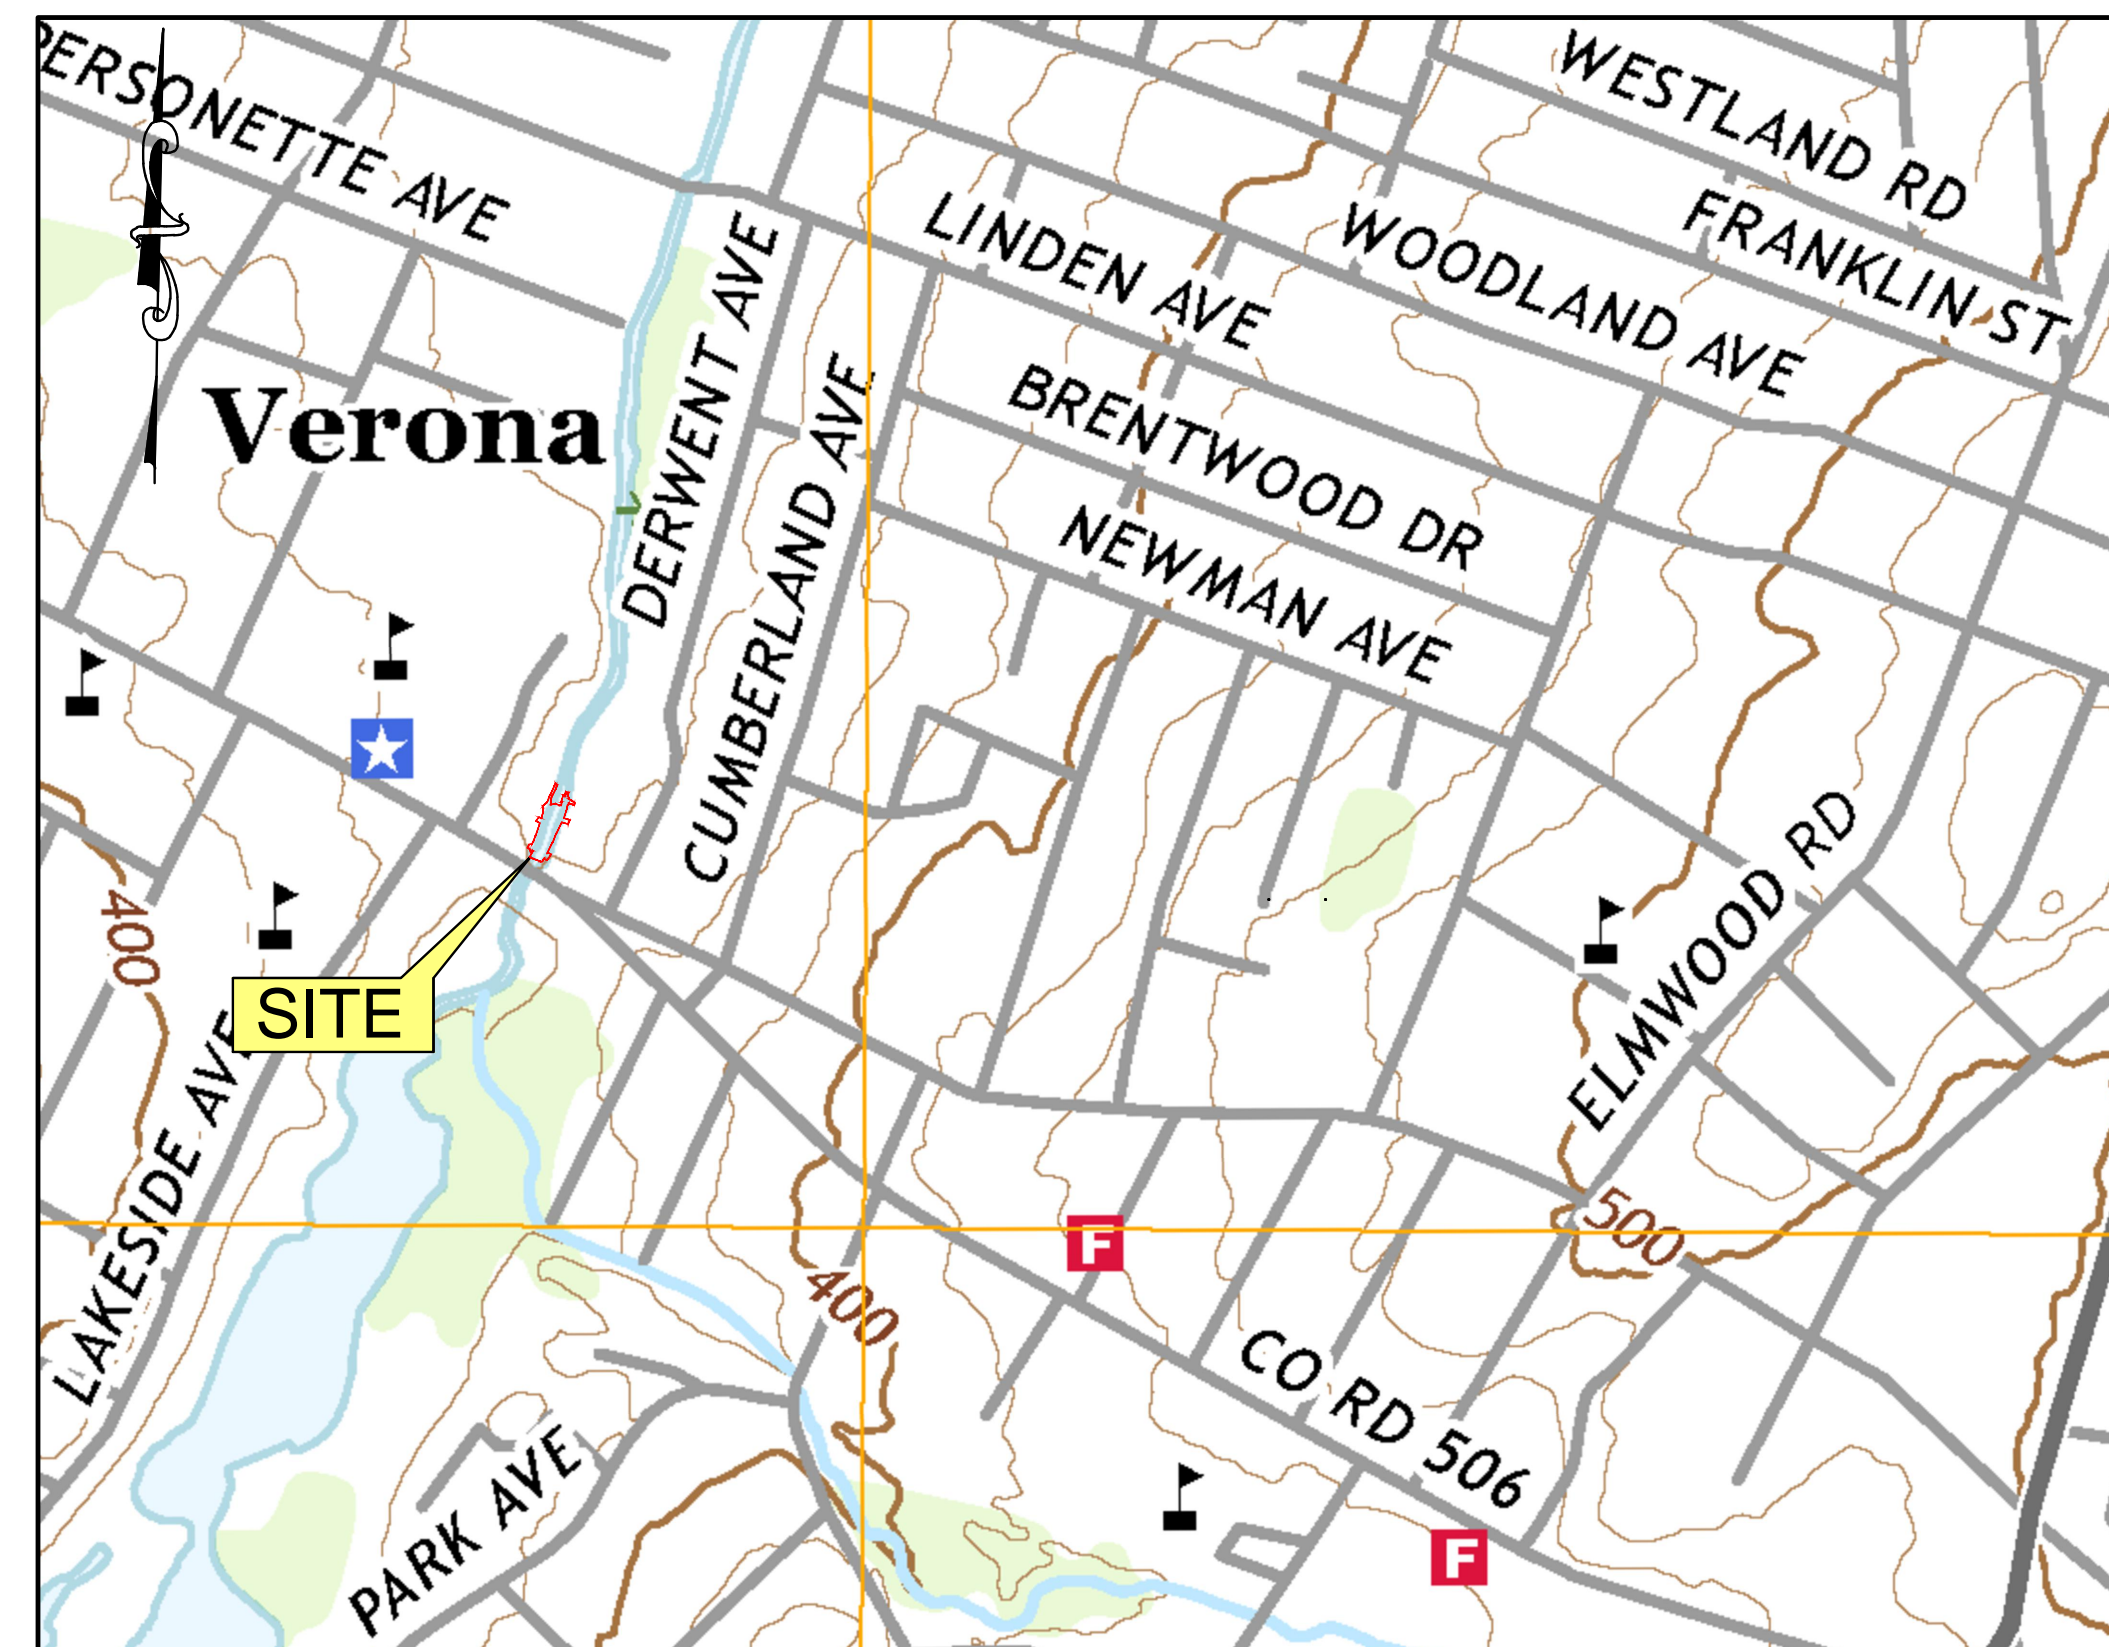

PROJECT LOCATION MAP

1" = 500'

INDEX OF SHEETS

SHEET NUMBER	SHEET TITLE
1	TITLE SHEET
2	EXISTING PLAN
3	SITE PLAN
4	ENVIRONMENTAL PLAN
5	CROSS SECTIONS -1
6	CROSS SECTIONS - 2
7	SWALE CROSS SECTIONS
8	PLANTING PLAN
9	CONSTRUCTION DETAILS
10	SOIL EROSION AND SEDIMENT CONTROL PLAN
11	SOIL EROSION AND SEDIMENT CONTROL DETAILS



BOSWELL ENGINEERING

330 PHILLIPS AVENUE

SOUTH HACKENSACK, NEW JERSEY 07606

Tel (201) 641-0770 . Fax (201) 641-1831

NJ Certificate of Authorization No. 24GA27958000

KEVIN J. BOSWELL
PROFESSIONAL ENGINEER N.J. LIC. 32943


JOSEPH A. POMANTE
PROFESSIONAL ENGINEER N.J. LIC. 43137

JOB NO. VA-102

OCTOBER 20, 2023

VA-102-TS

SHEET 1 OF 11

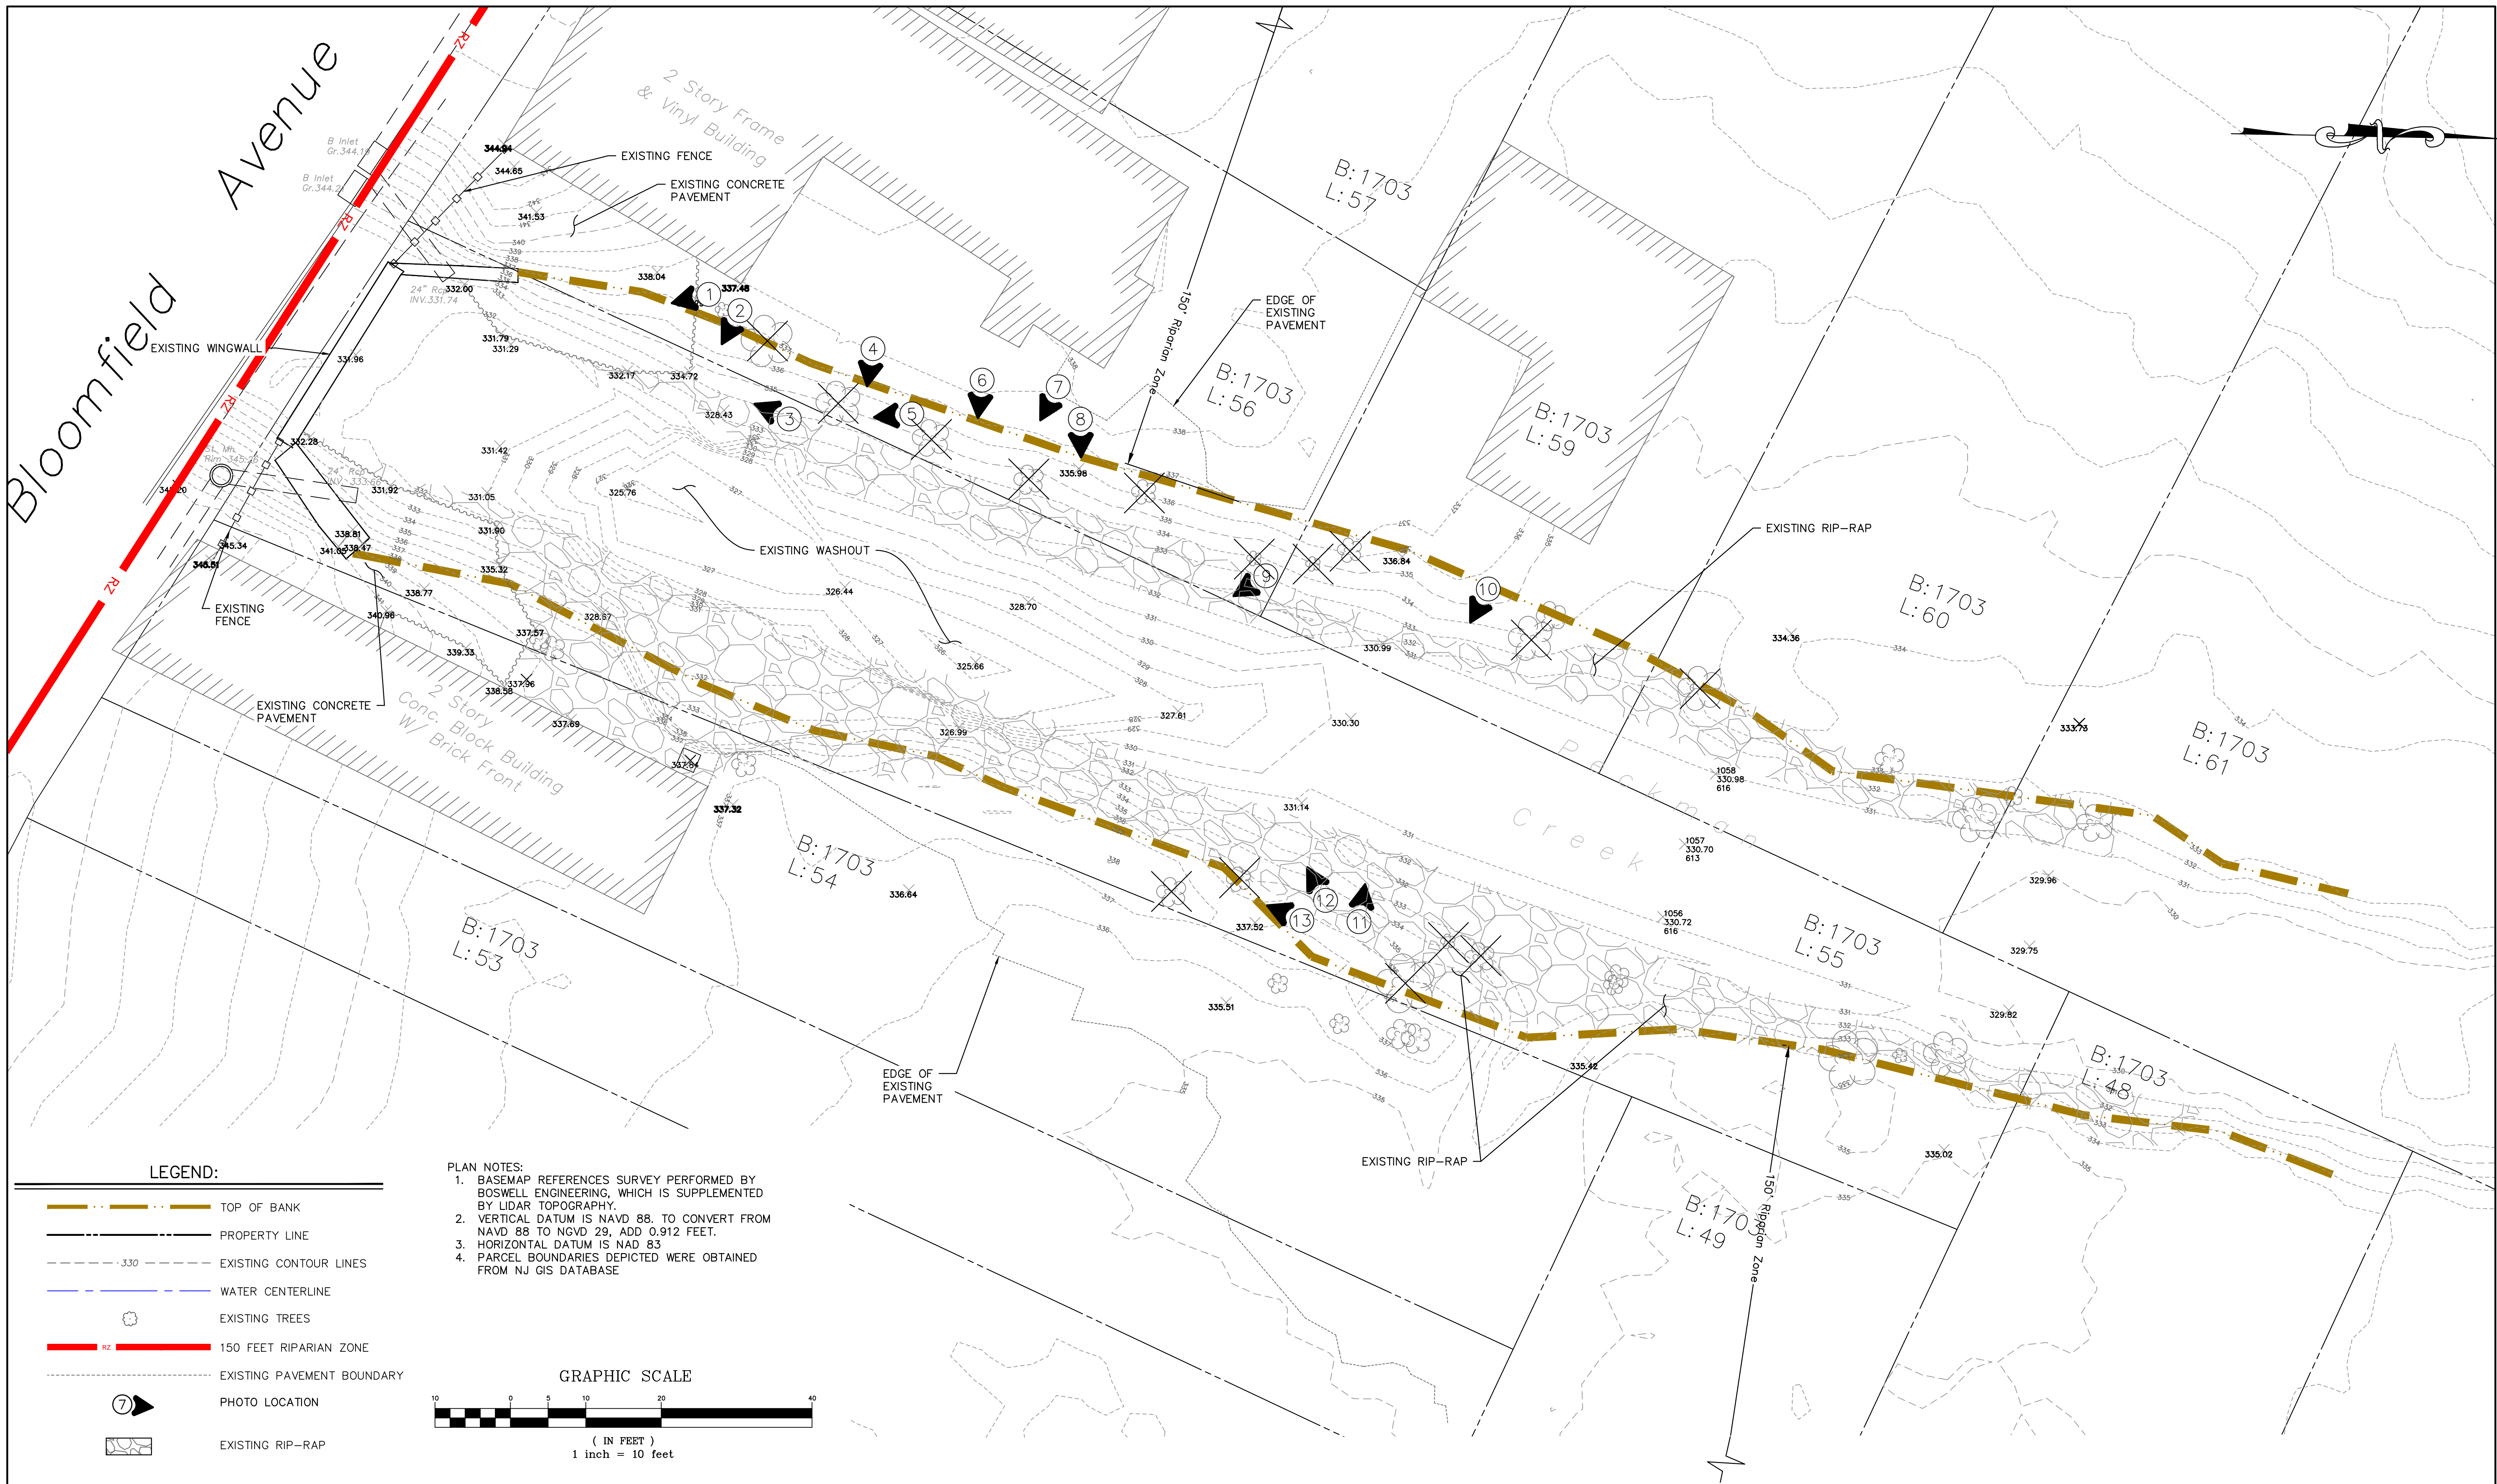


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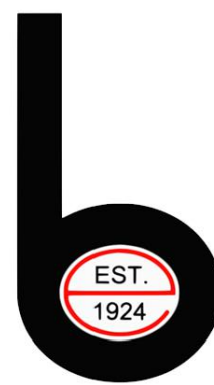
- TOP OF BANK
- PROPERTY LINE
- EXISTING CONTOUR LINES
- WATER CENTERLINE
- EXISTING TREES
- 150 FEET RIPARIAN ZONE
- EXISTING PAVEMENT BOUNDARY
- PHOTO LOCATION
- EXISTING RIP-RAP

PLAN NOTES:
1. BASEMAP REFERENCES SURVEY PERFORMED BY BOSWELL ENGINEERING, WHICH IS SUPPLEMENTED BY LIDAR TOPOGRAPHY.
2. VERTICAL DATUM IS NAVD 88. TO CONVERT FROM NAVD 88 TO NGVD 29, ADD 0.912 FEET.
3. HORIZONTAL DATUM IS NAD 83
4. PARCEL BOUNDARIES DEPICTED WERE OBTAINED FROM NJ GIS DATABASE

GRAPHIC SCALE

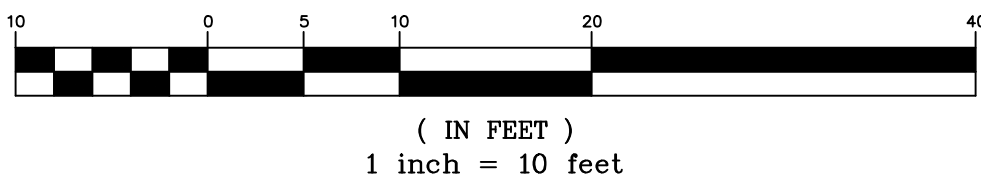

1	05/06/24	REVISED PER DEP COMMENTS		LLJ	RX	FJR
NO.	DATE	DESCRIPTION	SURVEYED BY	DRAWN BY	DESIGNED BY	CHECKED BY



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N.J. CERTIFICATE OF AUTHORIZATION No. 24GA27958000

KEVIN J. BOSWELL


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JOSEPH A. POMANTE

PROFESSIONAL ENGINEER N.J. LIC. 43137

BANK STABILIZATION ALONG THE PECKMAN RIVER
BLOCK 1703 LOTS 54, 55, 56, 59, 60
EXISTING CONDITIONS PLAN
TOWNSHIP OF VERONA

ESSEX COUNTY			NEW JERSEY		
SURVEYED BY DRAWN BY RX	DESIGNED BY SJ CHECKED BY FJR	SCALE: 1" = 10'	JOB NO. VA-102	DATE 10/26/23	
DRAWING NO. VA-102-EX.DWG					SHEET 2 OF 11

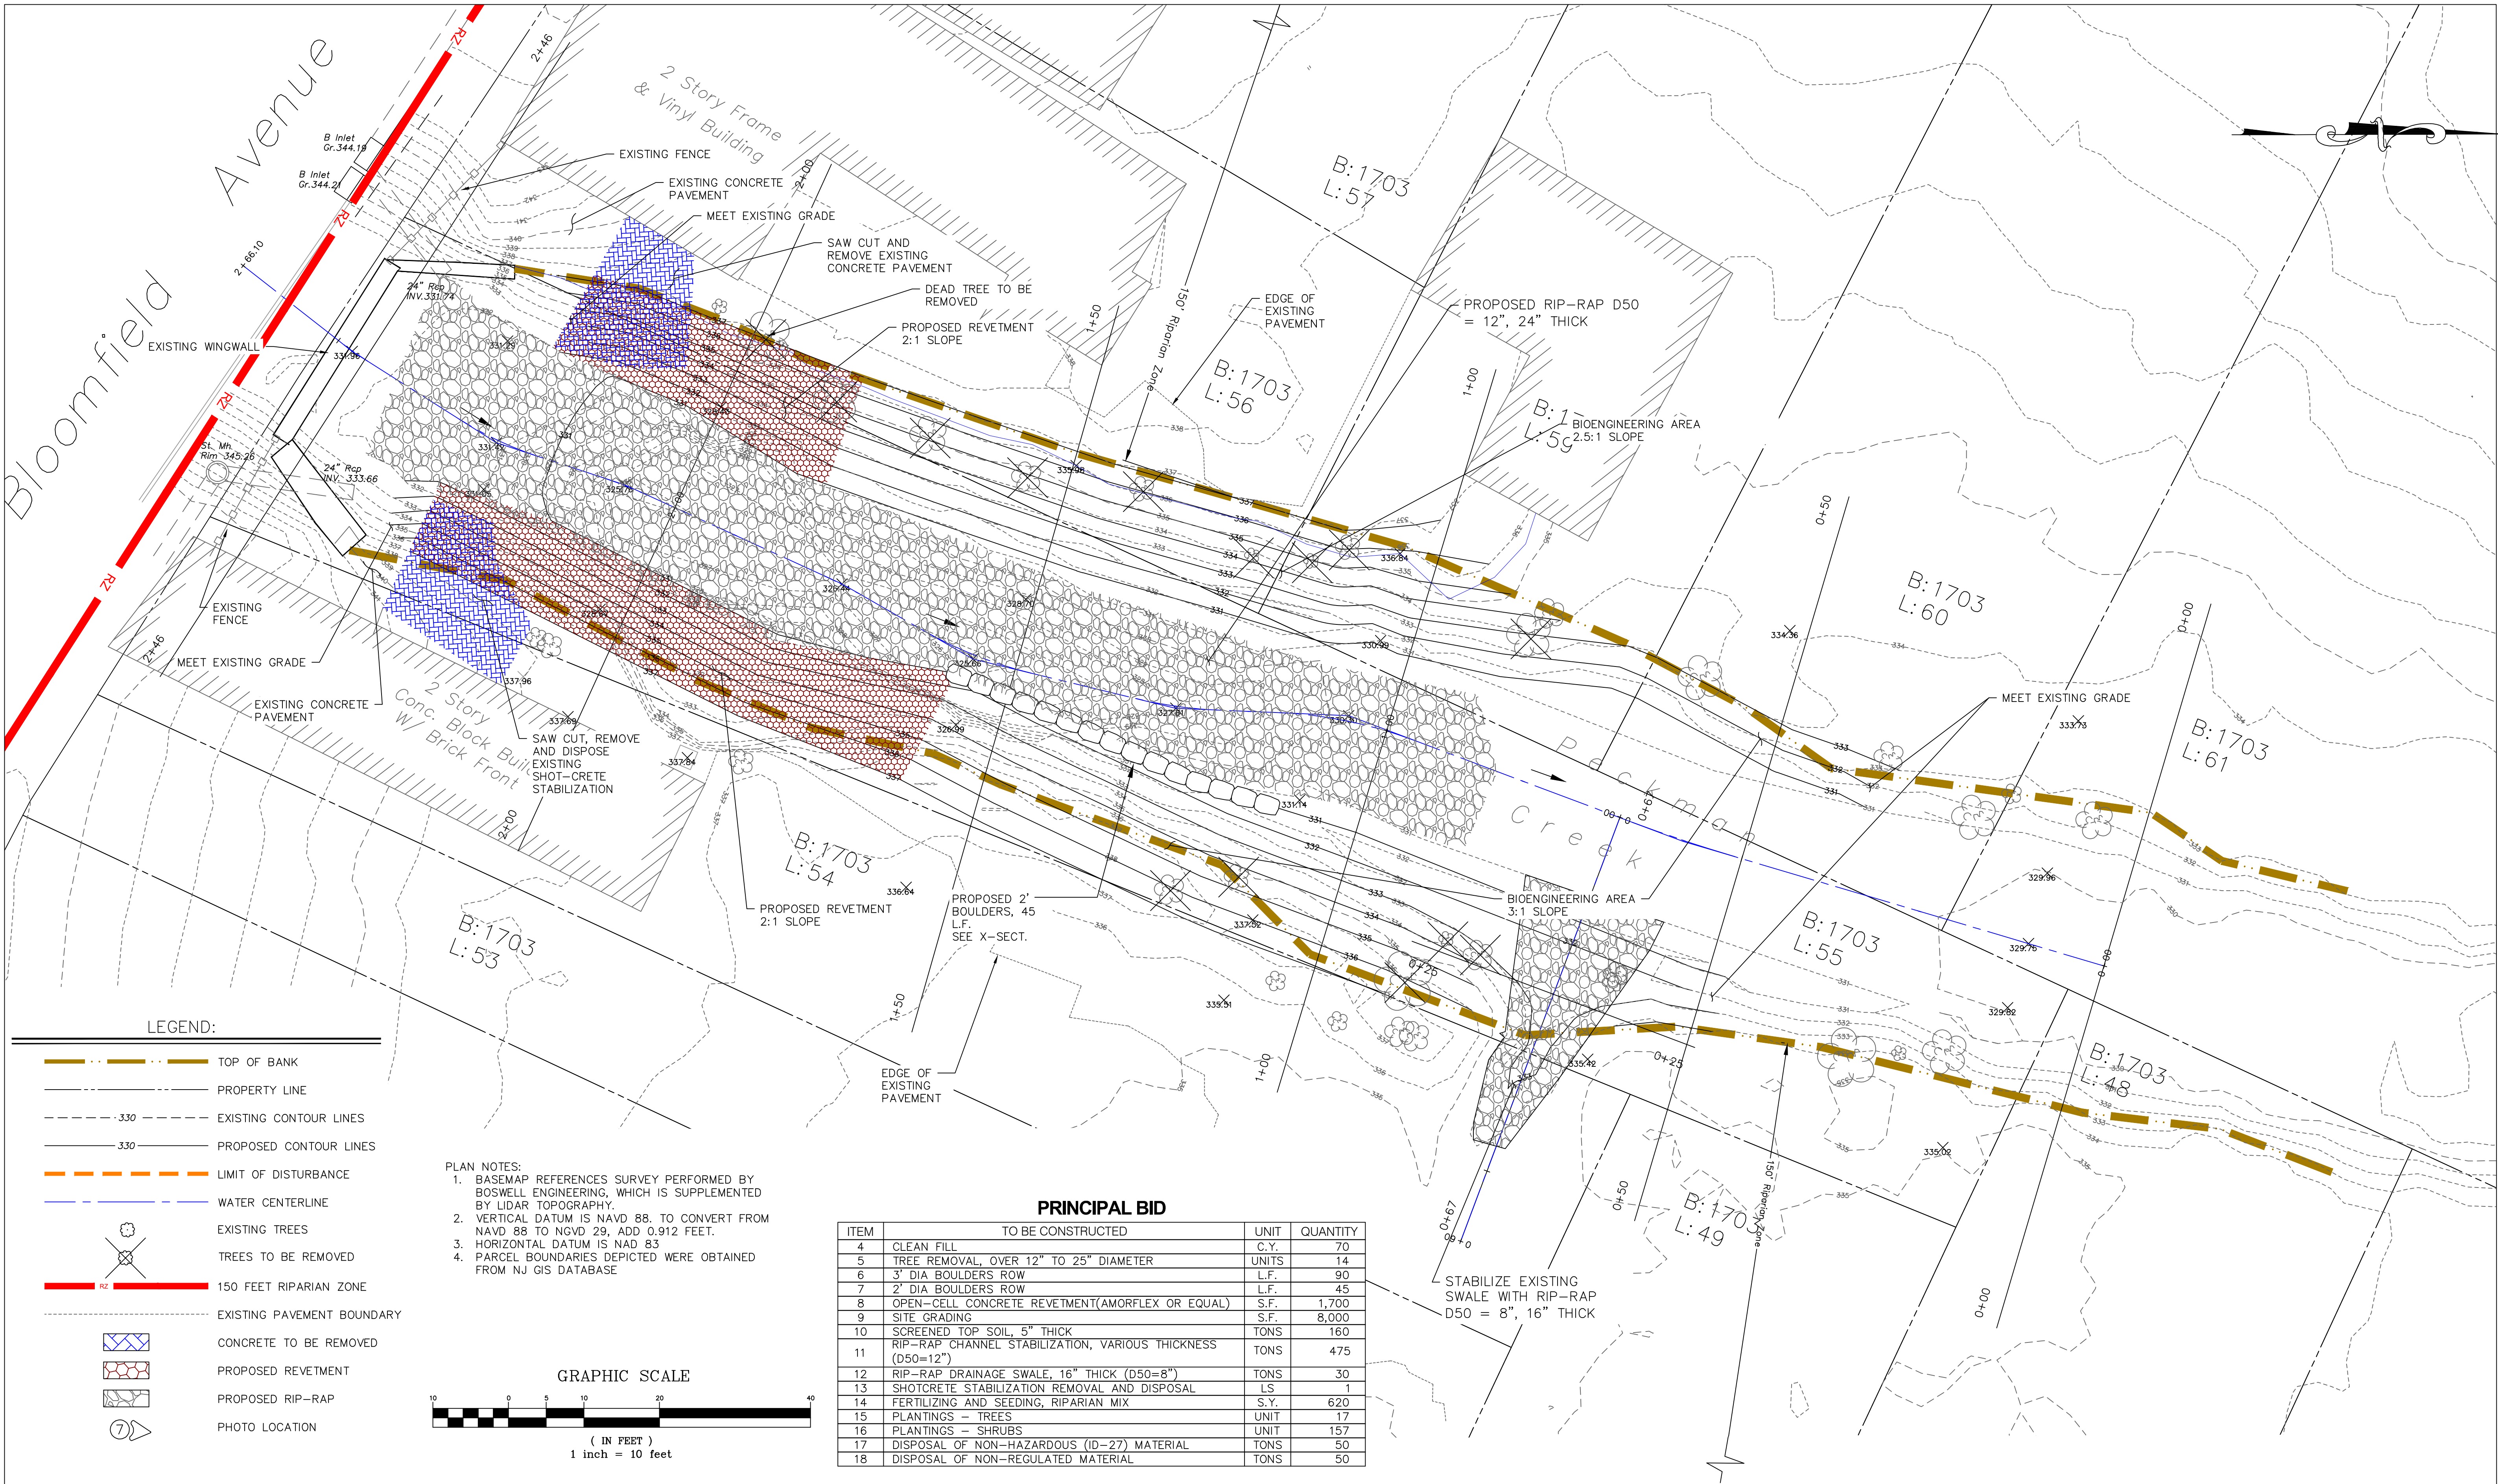

3	04/11/25	REVISED PER DEP COMMENTS			RX	RX	FJR		
2	05/07/24	REVISED PER DEP COMMENTS			LLJ	RX	FJR		
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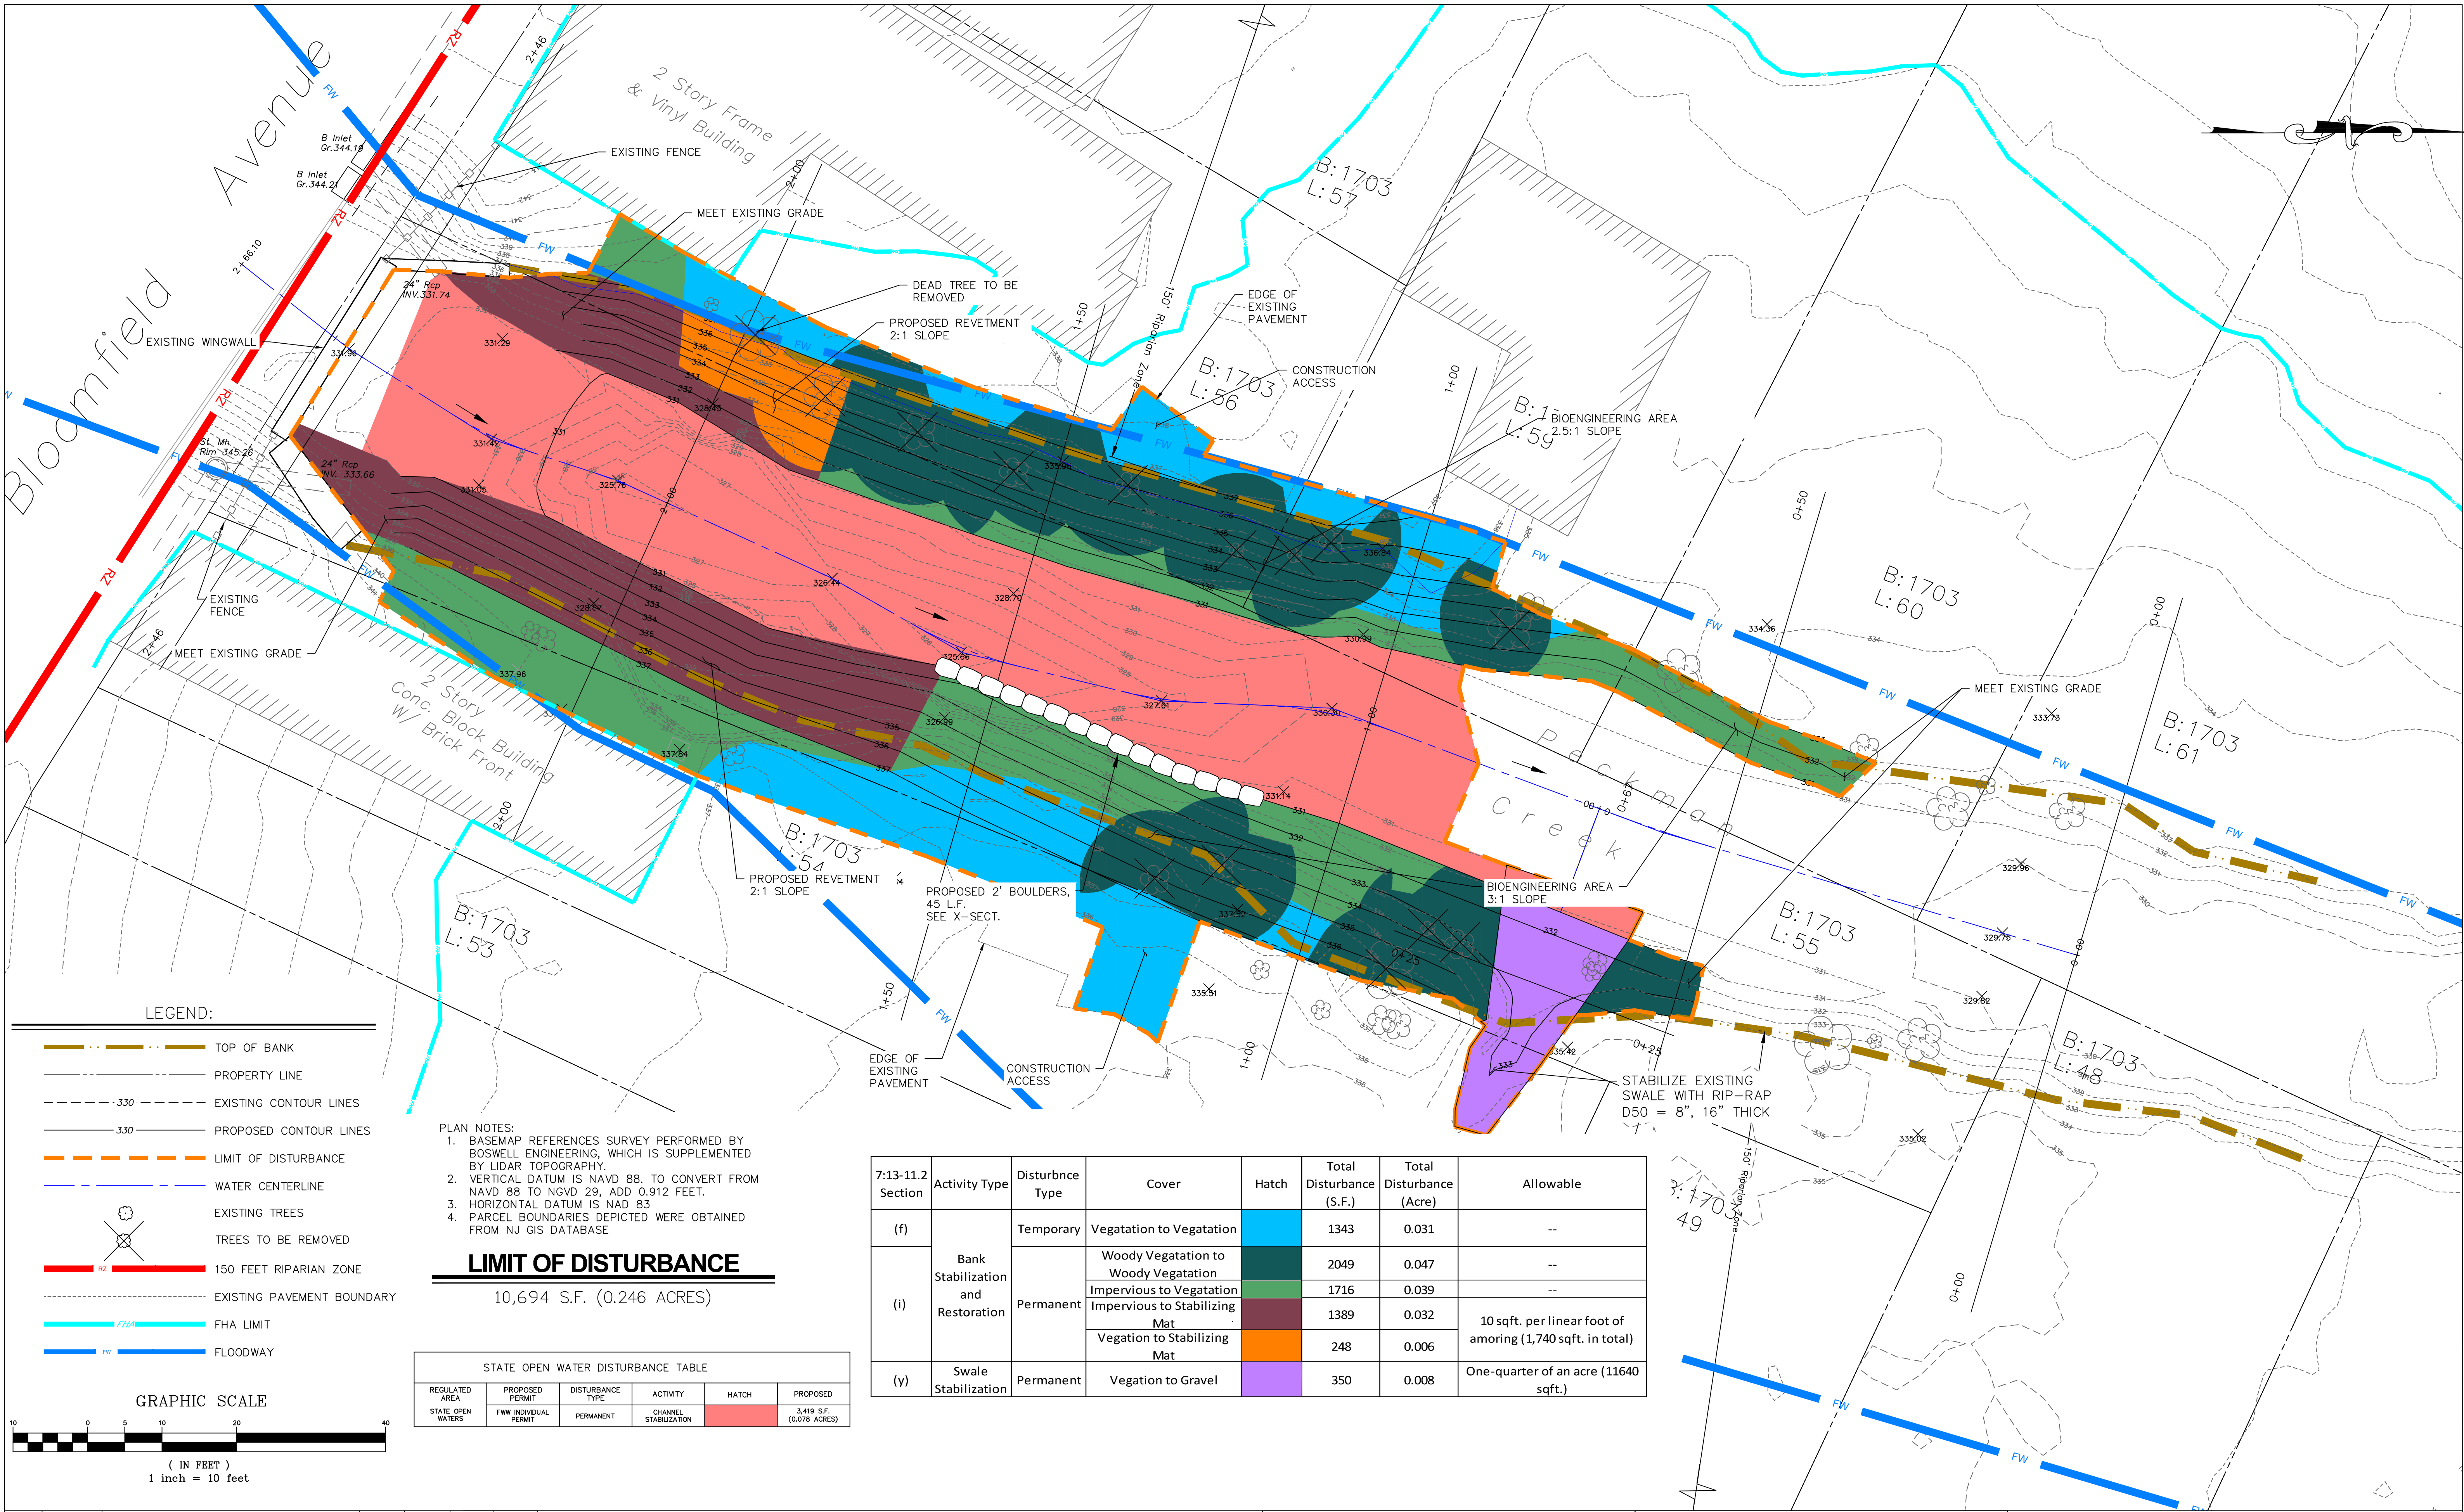
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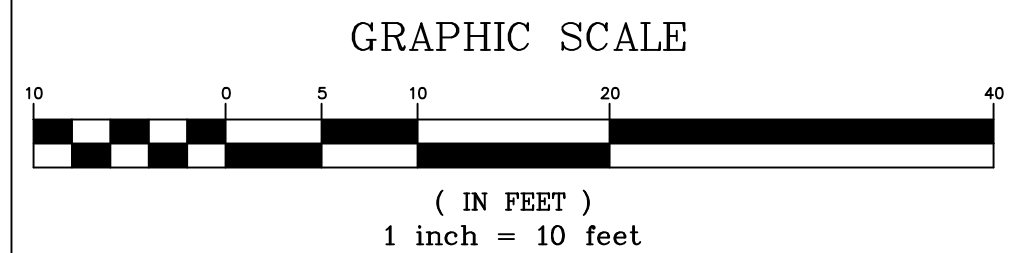
BANK STABILIZATION ALONG THE PECKMAN RIVER
BLOCK 1703 LOT 54, 55, 56, 59, 60
SITE PLAN
TOWNSHIP OF VERONA

ESSEX COUNTY			NEW JERSEY		
SURVEYED BY DRAWN BY RX	DESIGNED BY CHECKED BY FJR	SCALE: 1" = 10'	JOB NO. VA-102	DATE 10/26/23	
DRAWING NO. VA-102-CP.DWG			SHEET 3 OF 11		



LEGEND:

- TOP OF BANK
- PROPERTY LINE
- EXISTING CONTOUR LINES
- PROPOSED CONTOUR LINES
- LIMIT OF DISTURBANCE
- WATER CENTERLINE
- EXISTING TREES
- TREES TO BE REMOVED
- 150 FEET RIPARIAN ZONE
- EXISTING PAVEMENT BOUNDARY
- FHA LIMIT
- FLOODWAY



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LIMIT OF DISTURBANCE

10,694 S.F. (0.246 ACRES)

STATE OPEN WATER DISTURBANCE TABLE					
REGULATED AREA	PROPOSED PERMIT	DISTURBANCE TYPE	ACTIVITY	HATCH	PROPOSED
STATE OPEN WATERS	FW INDIVIDUAL PERMIT	PERMANENT	CHANNEL STABILIZATION		3,419 S.F. (0.078 ACRES)

7:13-11.2 Section	Activity Type	Disturbnce Type	Cover	Hatch	Total Disturbance (S.F.)	Total Disturbance (Acre)	Allowable
(f)	Bank Stabilization and Restoration	Temporary	Vegetation to Vegetation		1343	0.031	--
(i)		Permanent	Woody Vegetation to Woody Vegetation		2049	0.047	--
			Impervious to Vegetation		1716	0.039	--
			Impervious to Stabilizing Mat		1389	0.032	10 sqft. per linear foot of amoring (1,740 sqft. in total)
			Vegetation to Stabilizing Mat		248	0.006	
(y)	Swale Stabilization	Permanent	Vegetation to Gravel		350	0.008	One-quarter of an acre (11640 sqft.)

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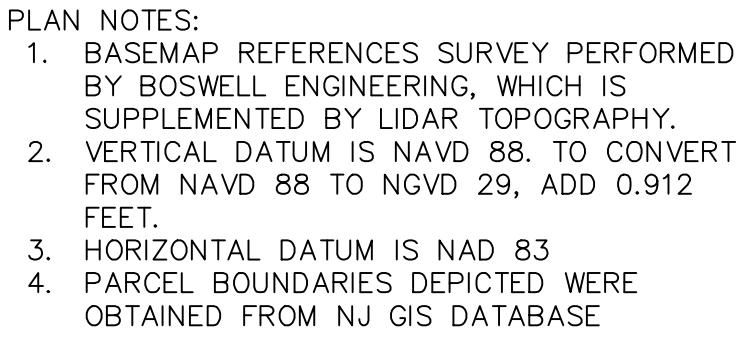
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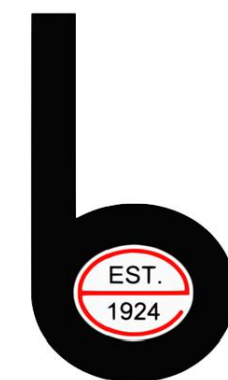
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N.J. CERTIFICATE OF AUTHORIZATION No. 24GA27958000

KEVIN J. BOSWELL	JOSEPH A. POMANTE	BANK STABILIZATION ALONG THE PECKMAN RIVER BLOCK 1703 LOT 54, 55, 56, 59, 60 ENVIRONMENTAL PLAN TOWNSHIP OF VERONA
PROFESSIONAL ENGINEER N.J. LIC. 32943	PROFESSIONAL ENGINEER N.J. LIC. 43137	ESSEX COUNTY NEW JERSEY
DRAWING NO. VA-102-CP.DWG		SHEET 4 OF 11



4	04/11/25	REVISED PER DEP COMMENTS		RX	RX	FJR	
3	05/07/24	REVISED PER DEP COMMENTS		LLJ	RX	FJR	
2	05/06/24	REVISED PER DEP COMMENTS		LLJ	RX	FJR	
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NO.	DATE	DESCRIPTION	SURVEYED BY	DRAWN BY	DESIGNED BY	CHECKED BY	




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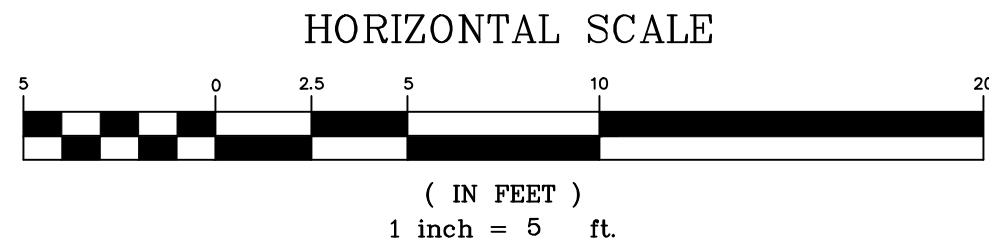
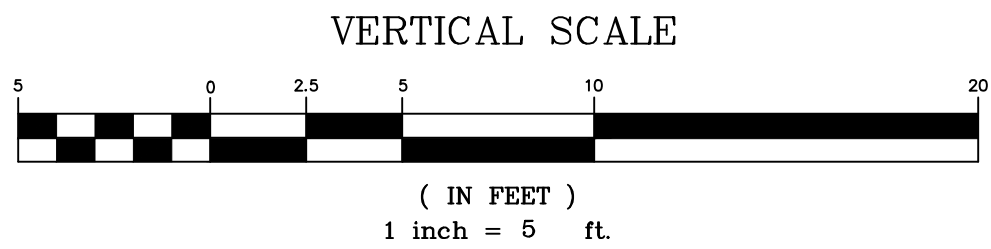
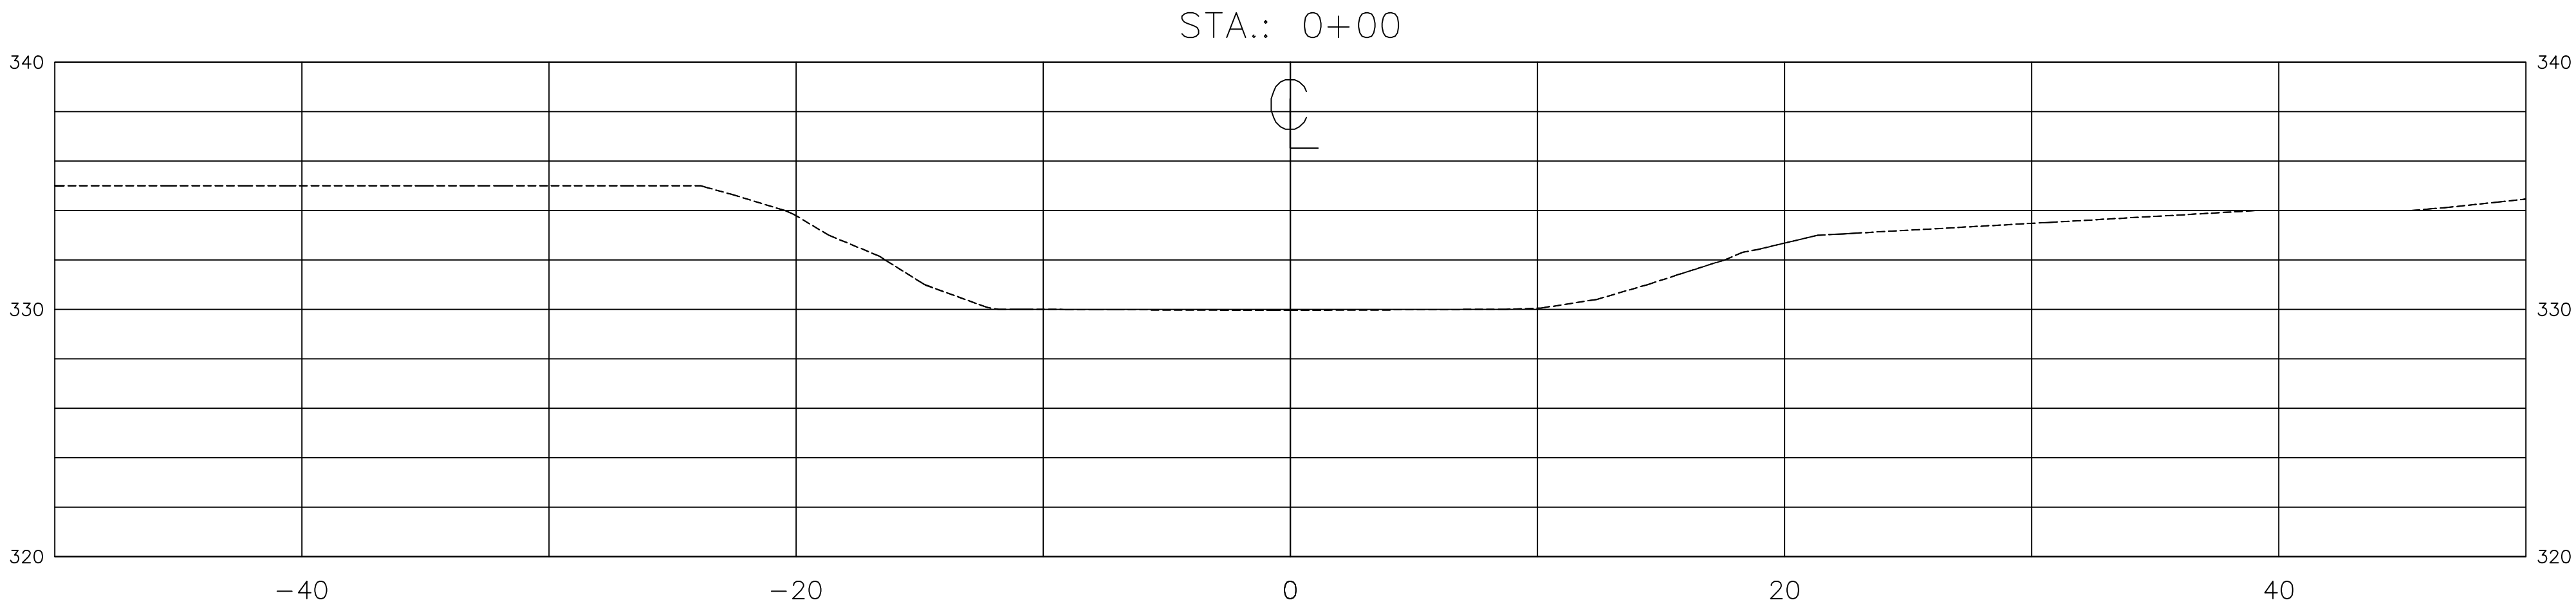
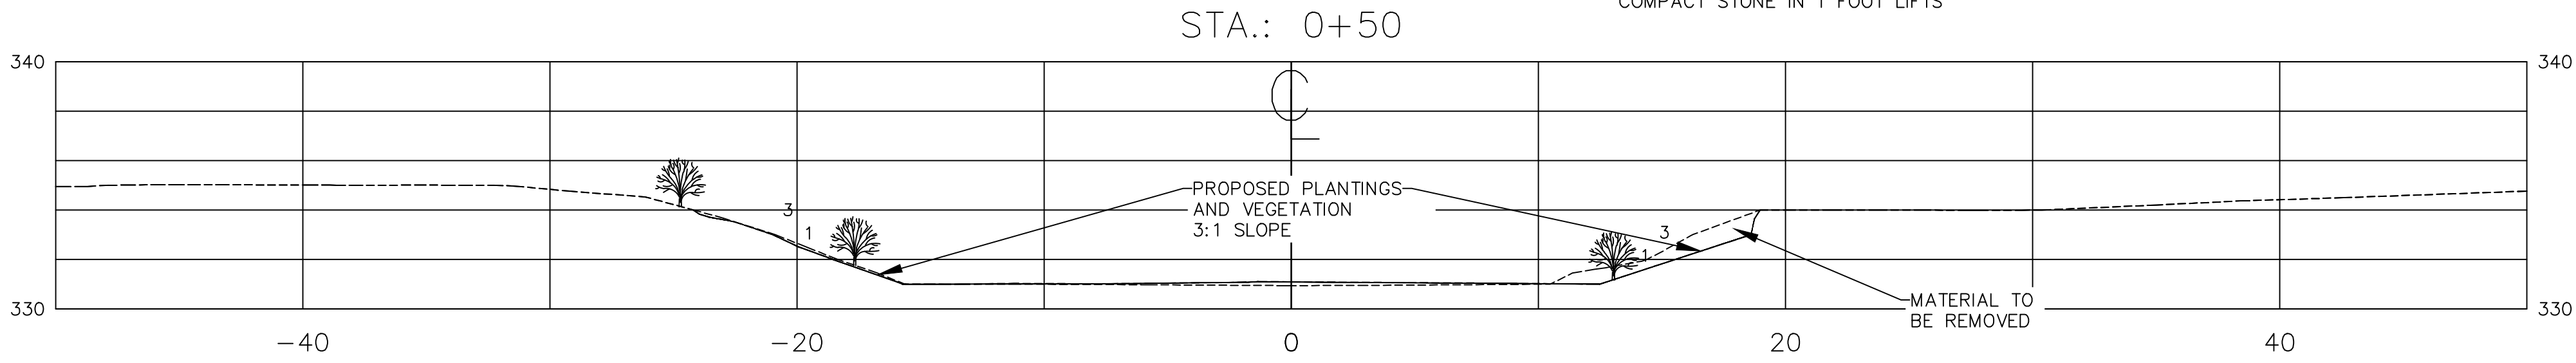
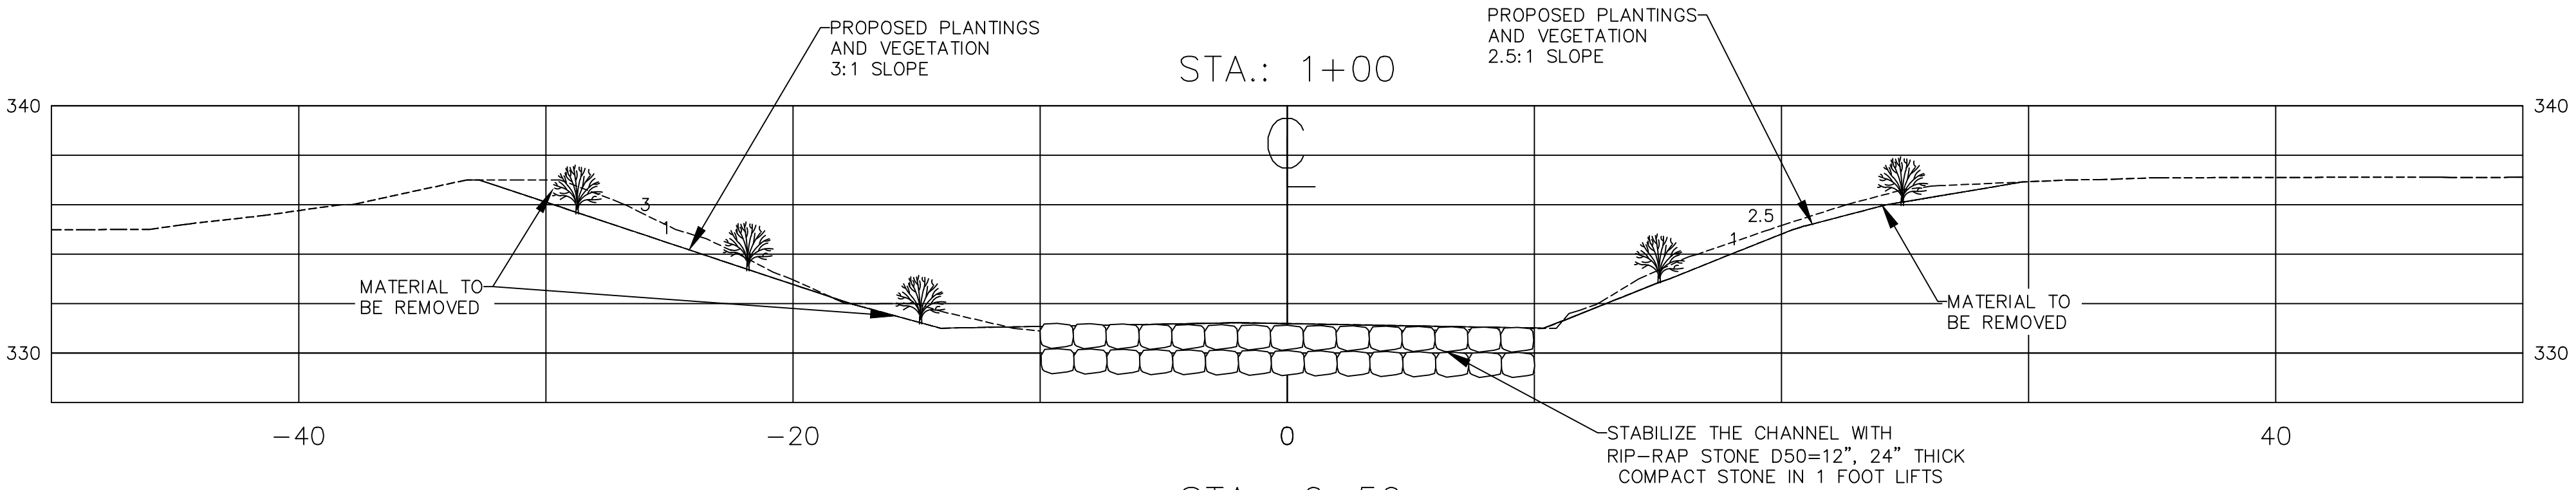
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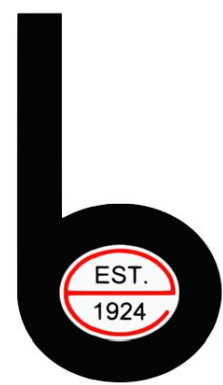
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DRAWING NO. VA-102-CP.DWG			SHEET 5	OF 11



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2	04/11/25	REVISED PER DEP COMMENTS		RX	RX	FJR
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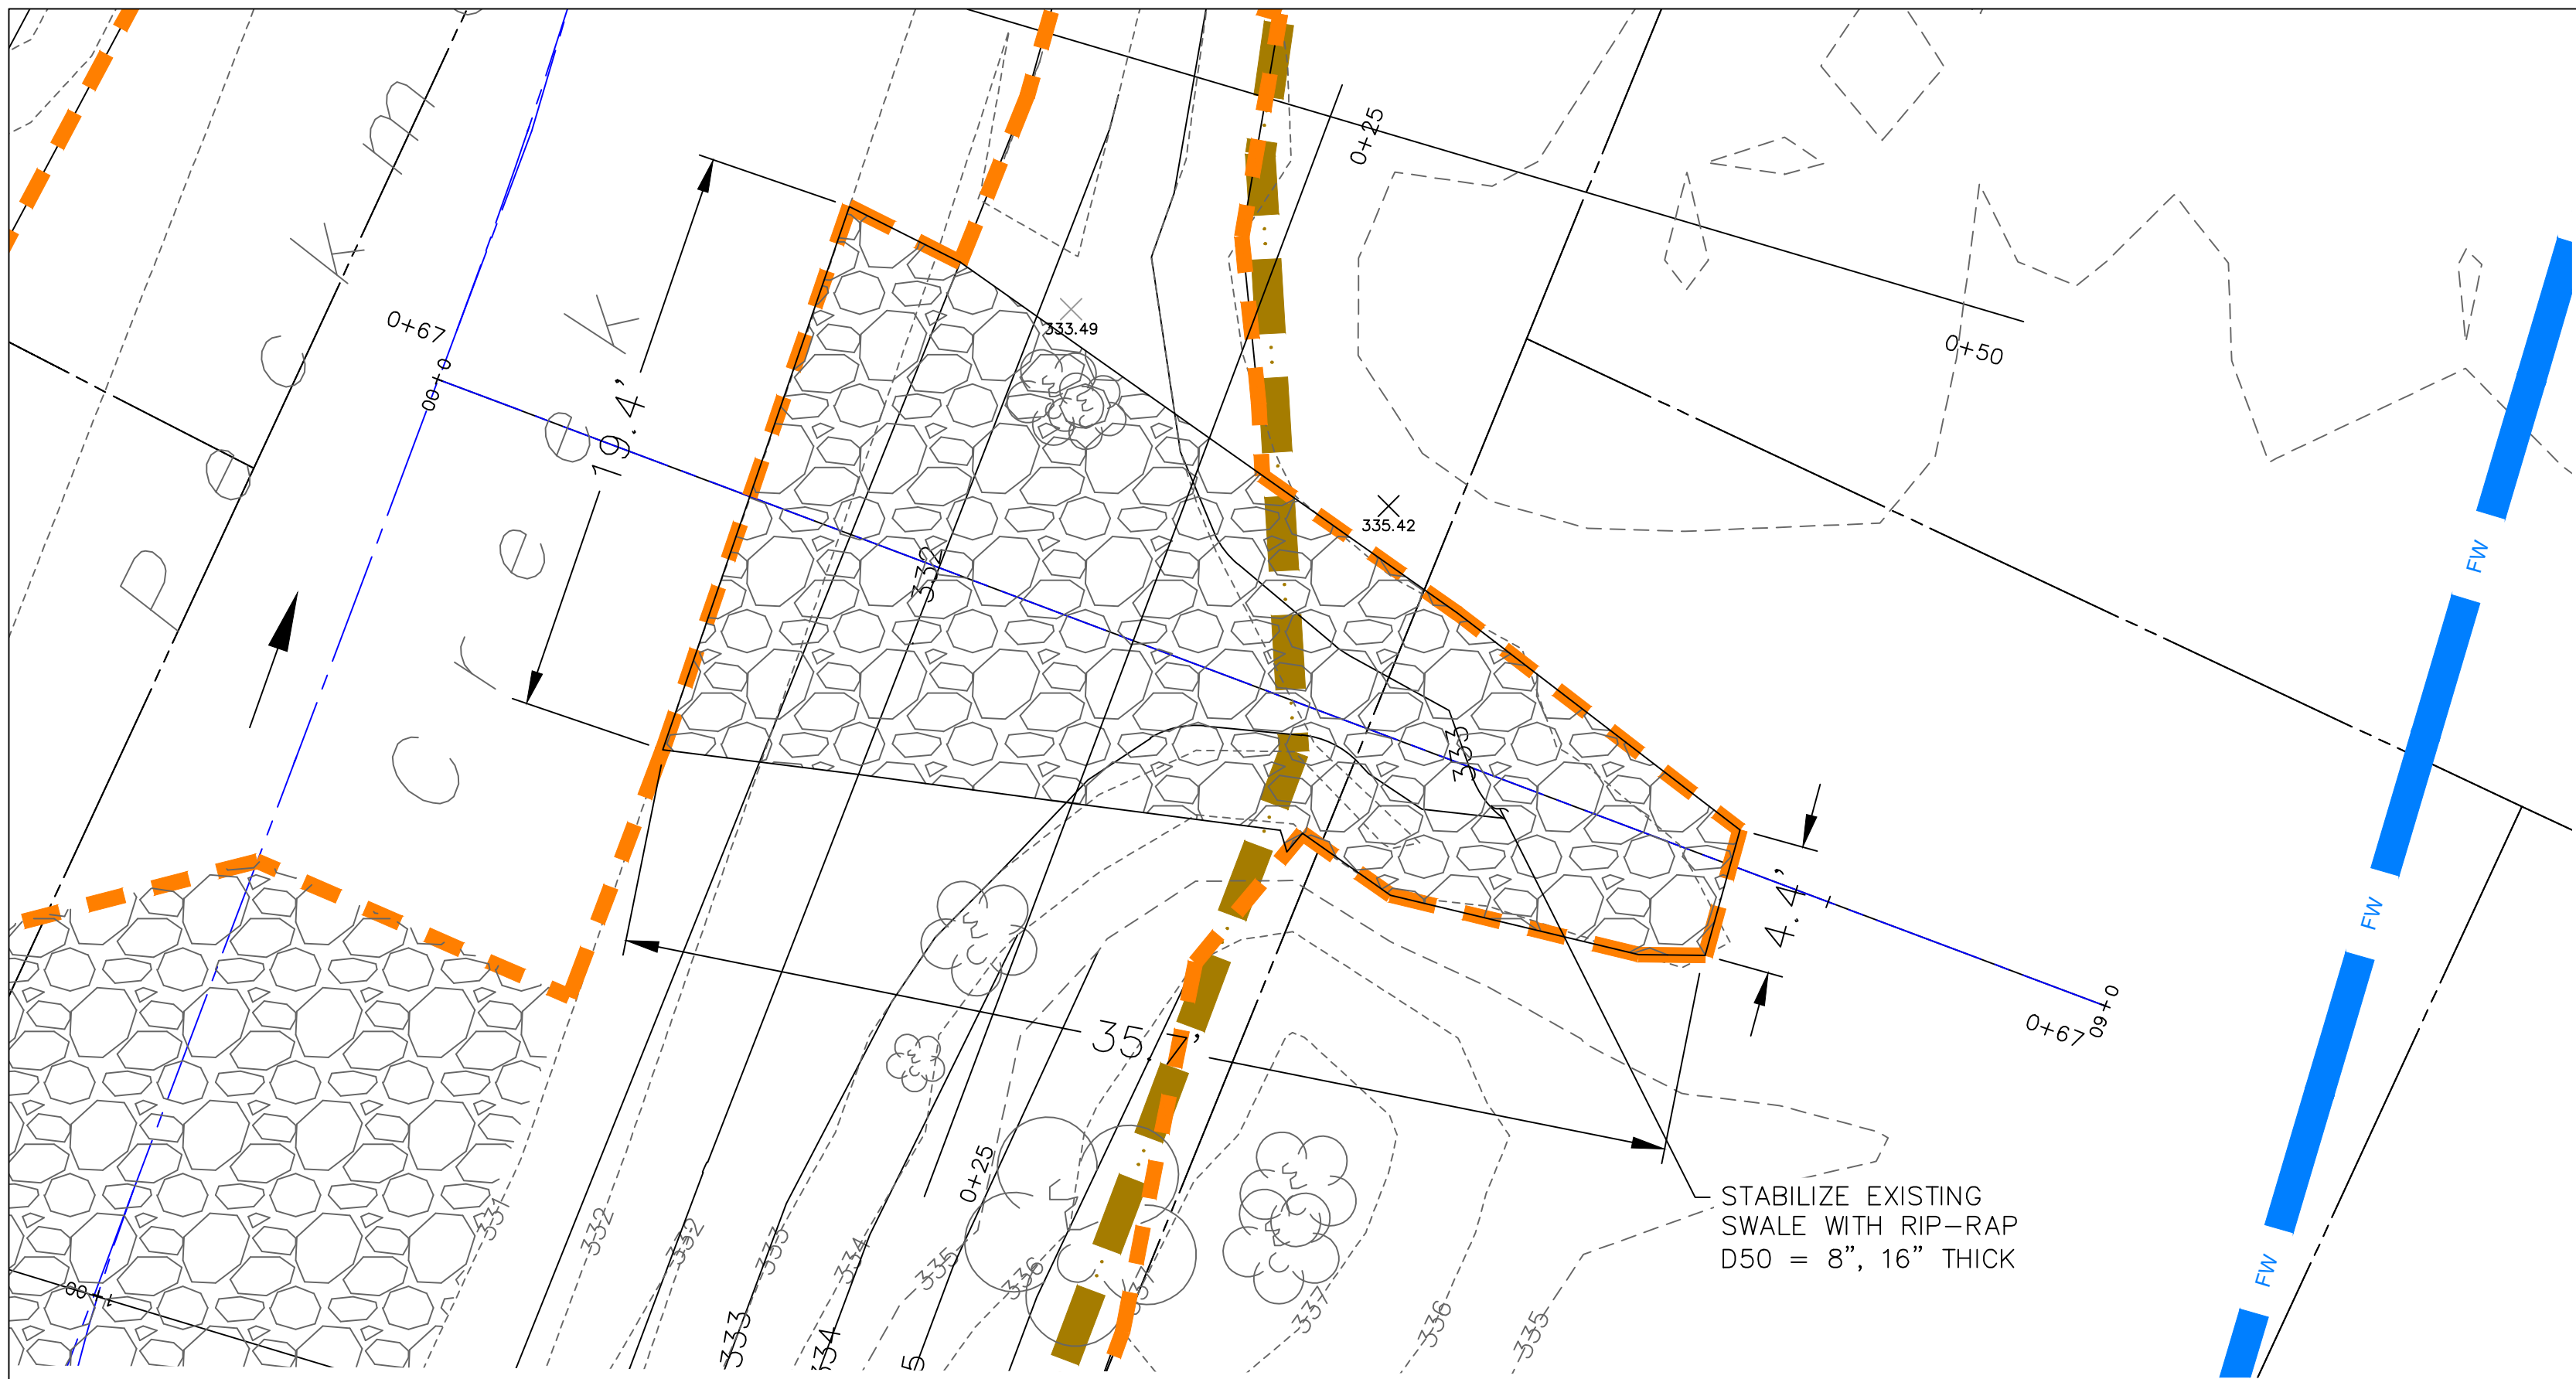
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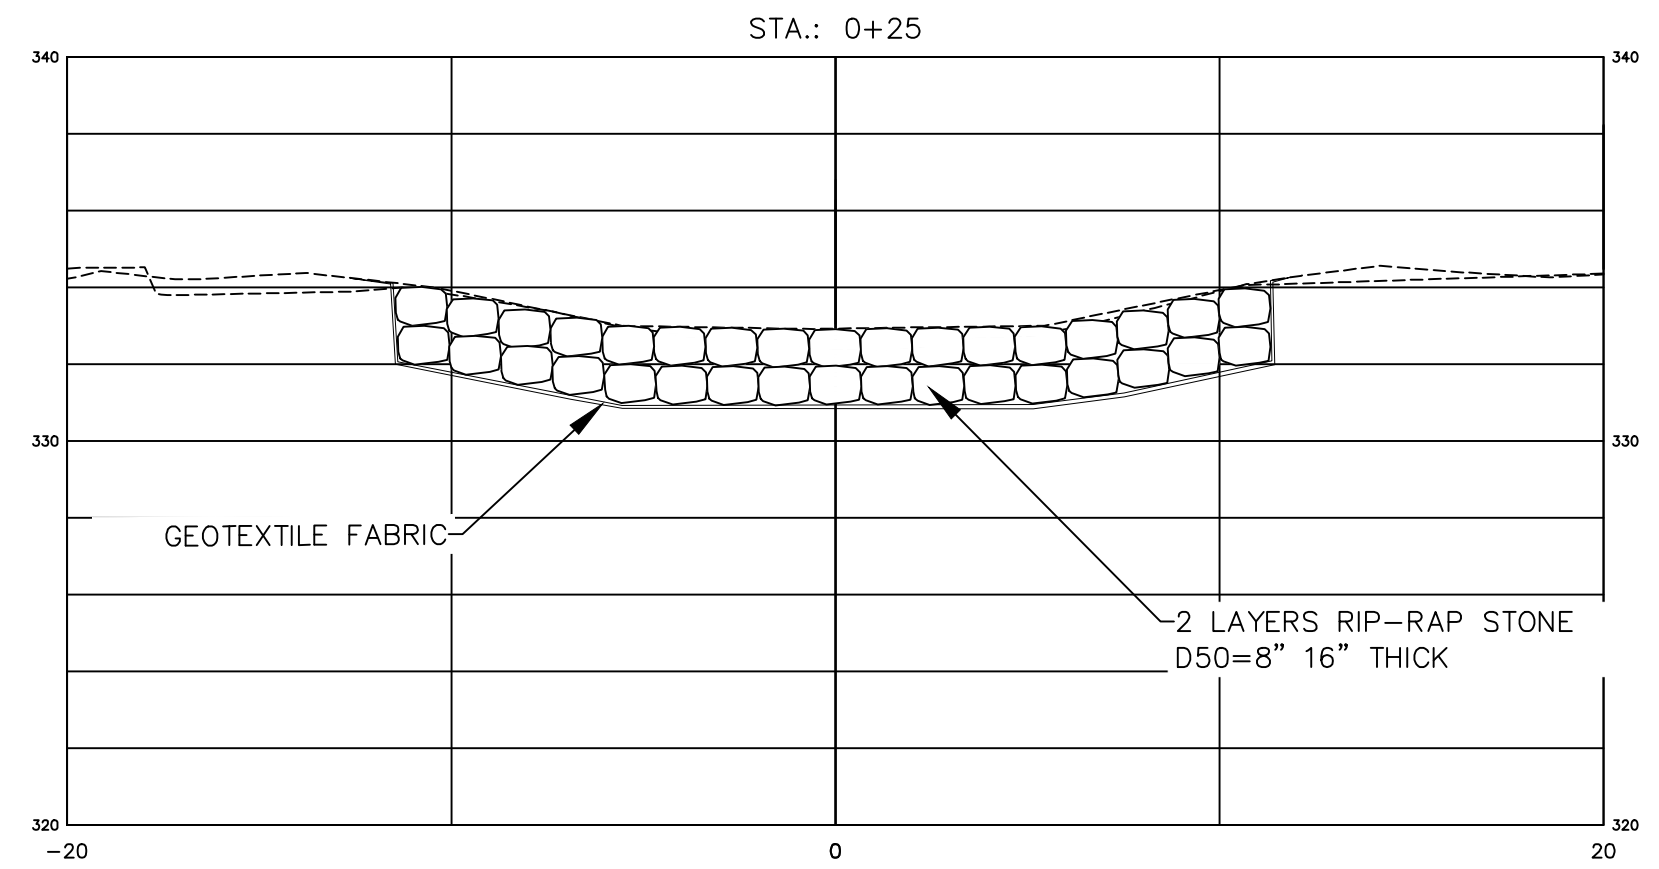
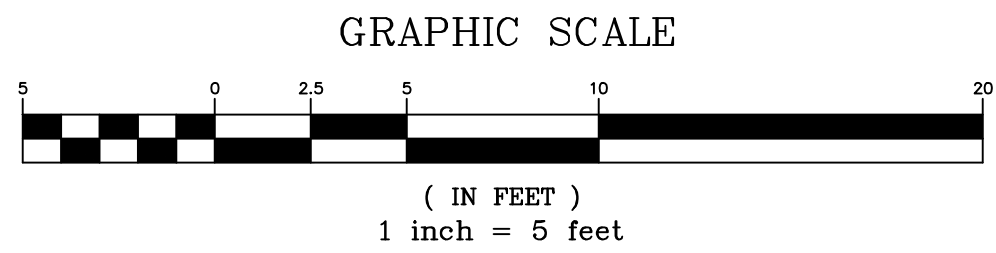
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BANK STABILIZATION ALONG THE PECKMAN RIVER
BLOCK 1703 LOT 54, 55, 56, 59, 60
CROSS SECTIONS - 2
TOWNSHIP OF VERONA


ESSEX COUNTY			NEW JERSEY		
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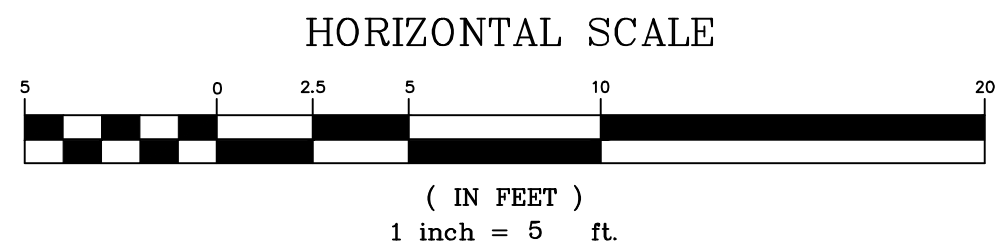
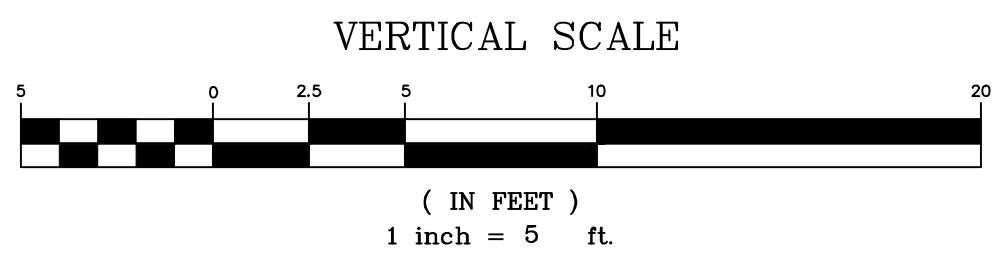
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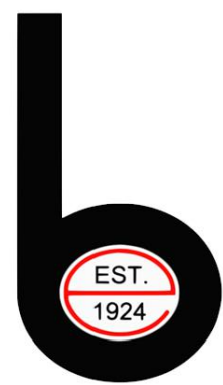
SECTION VIEW

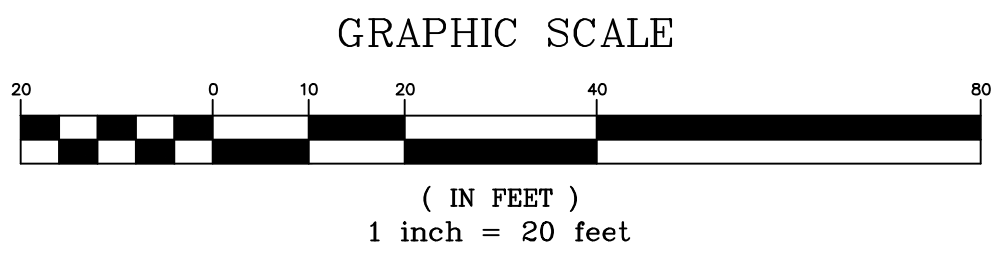

PROFILE VIEW



3	04/11/25	REVISED PER DEP COMMENTS		RX	RX	FJR
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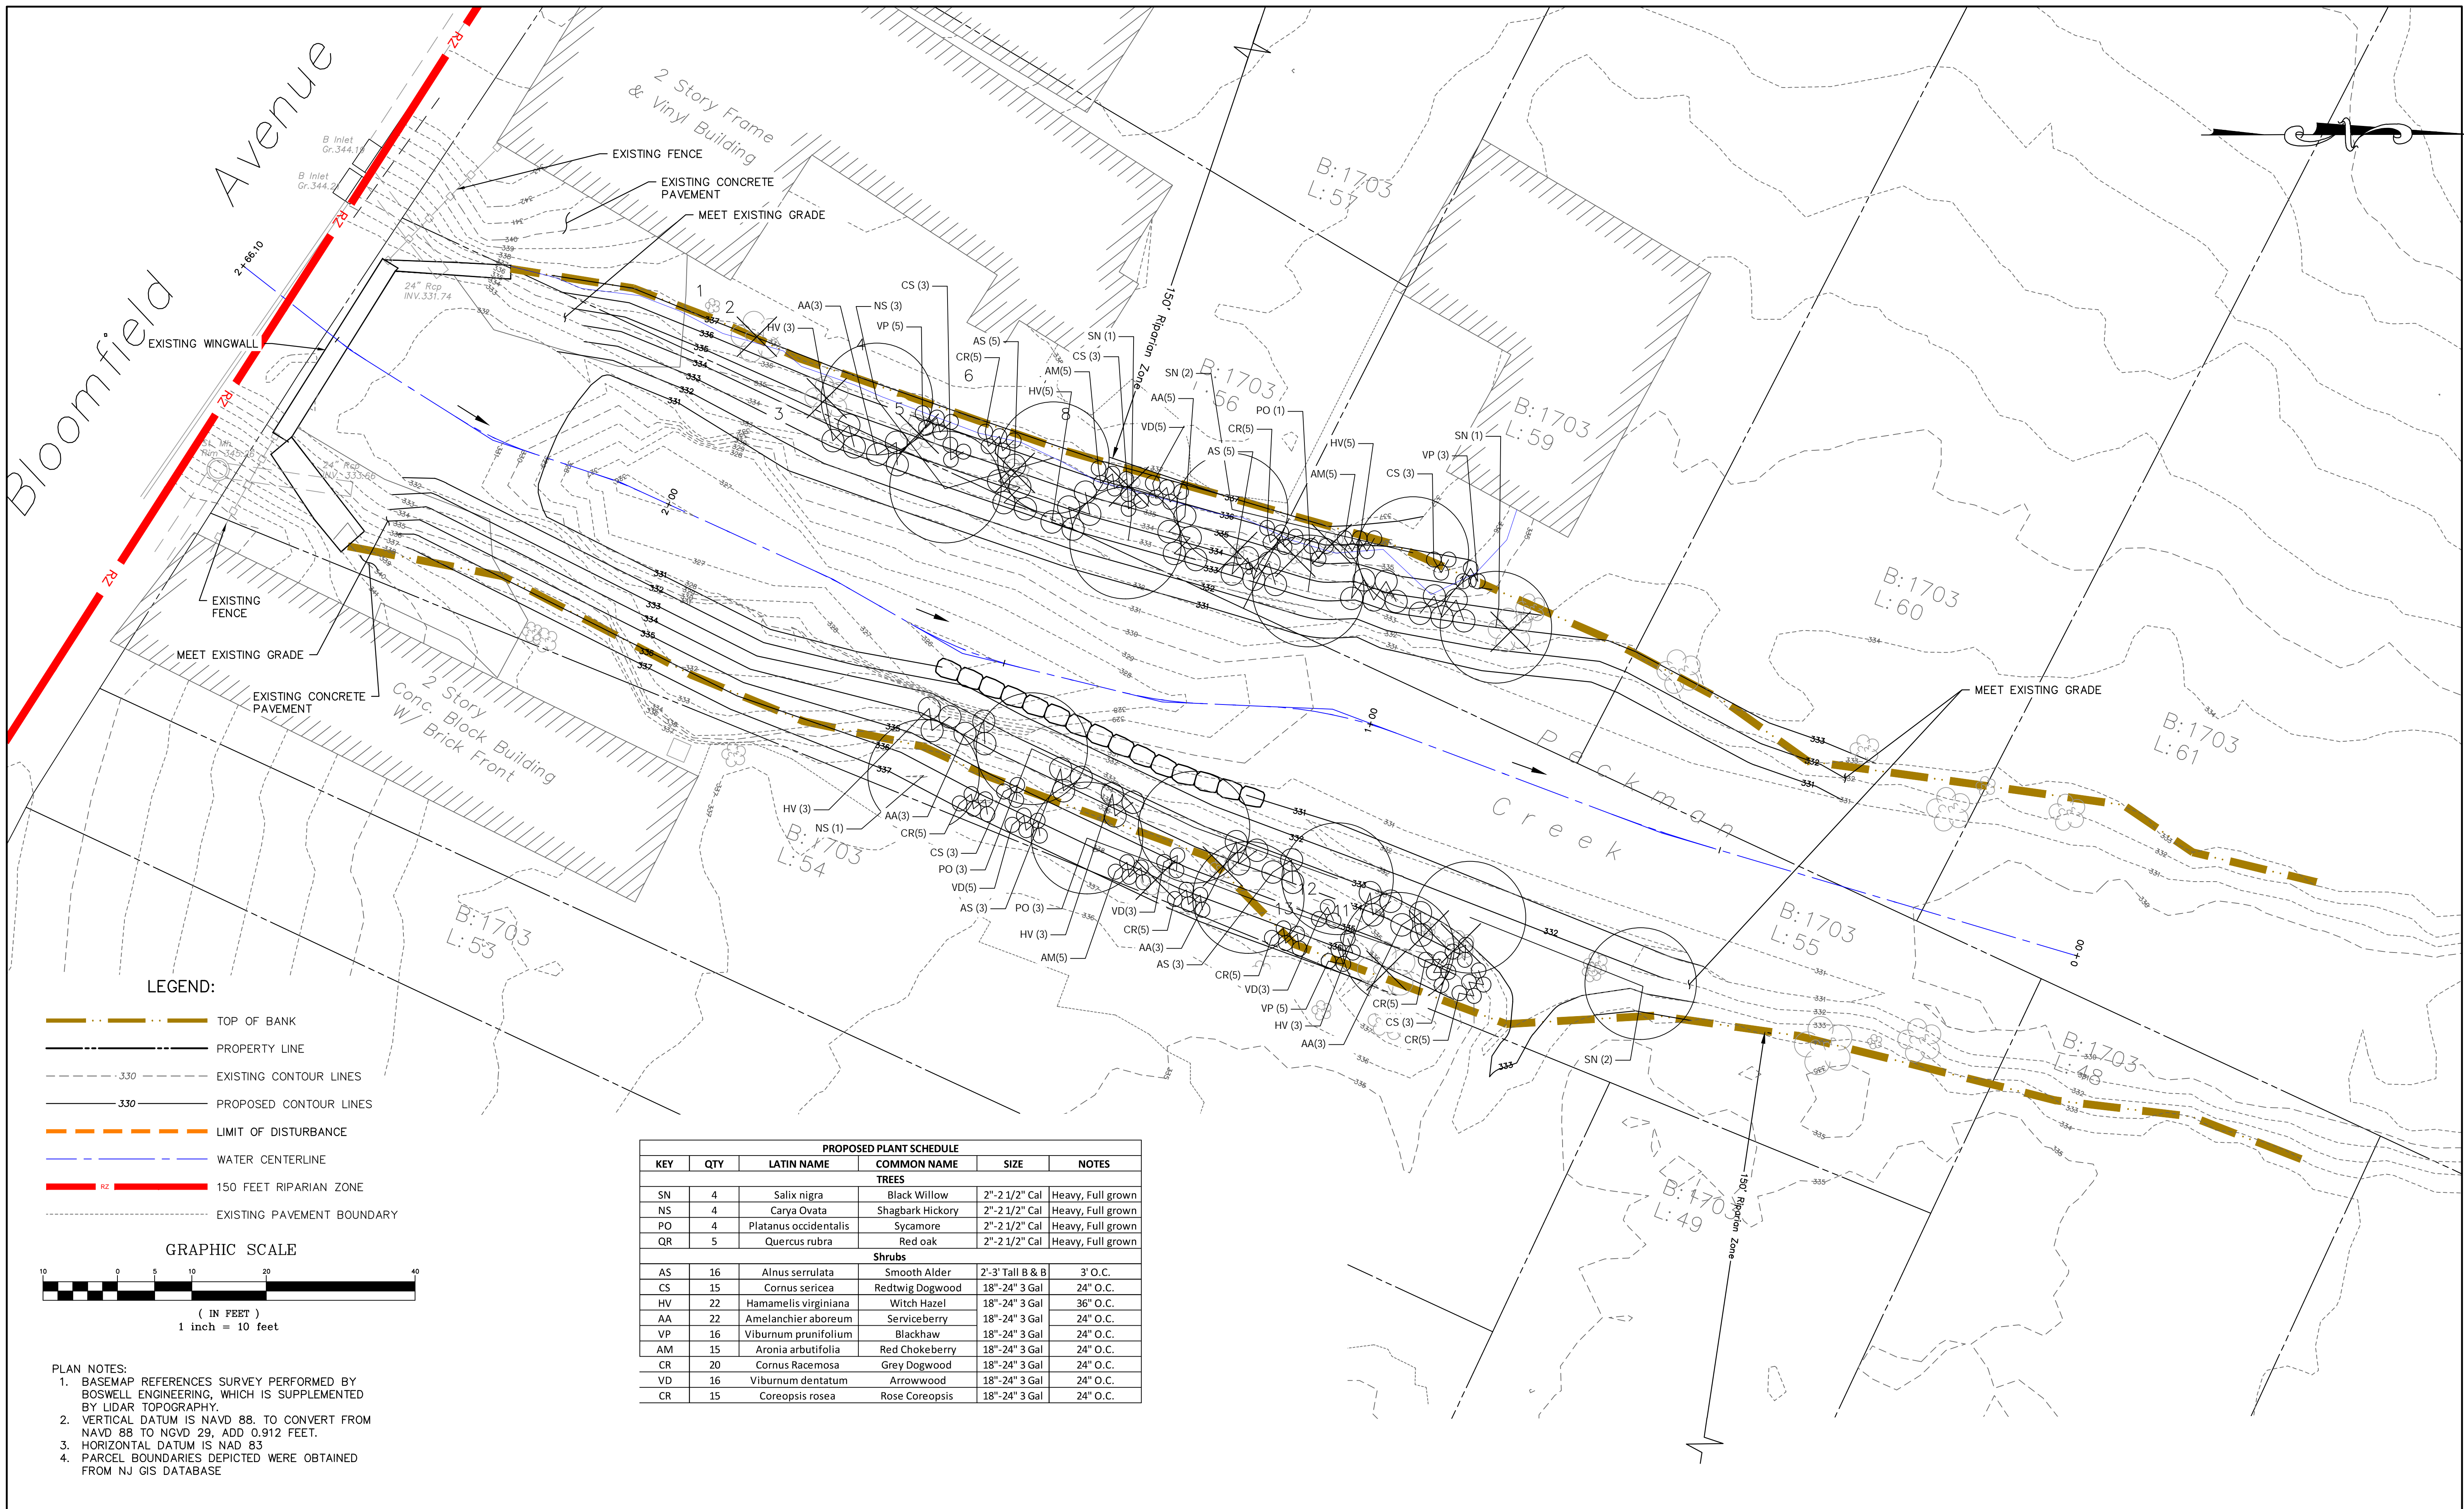
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JOSEPH A. POMANTE
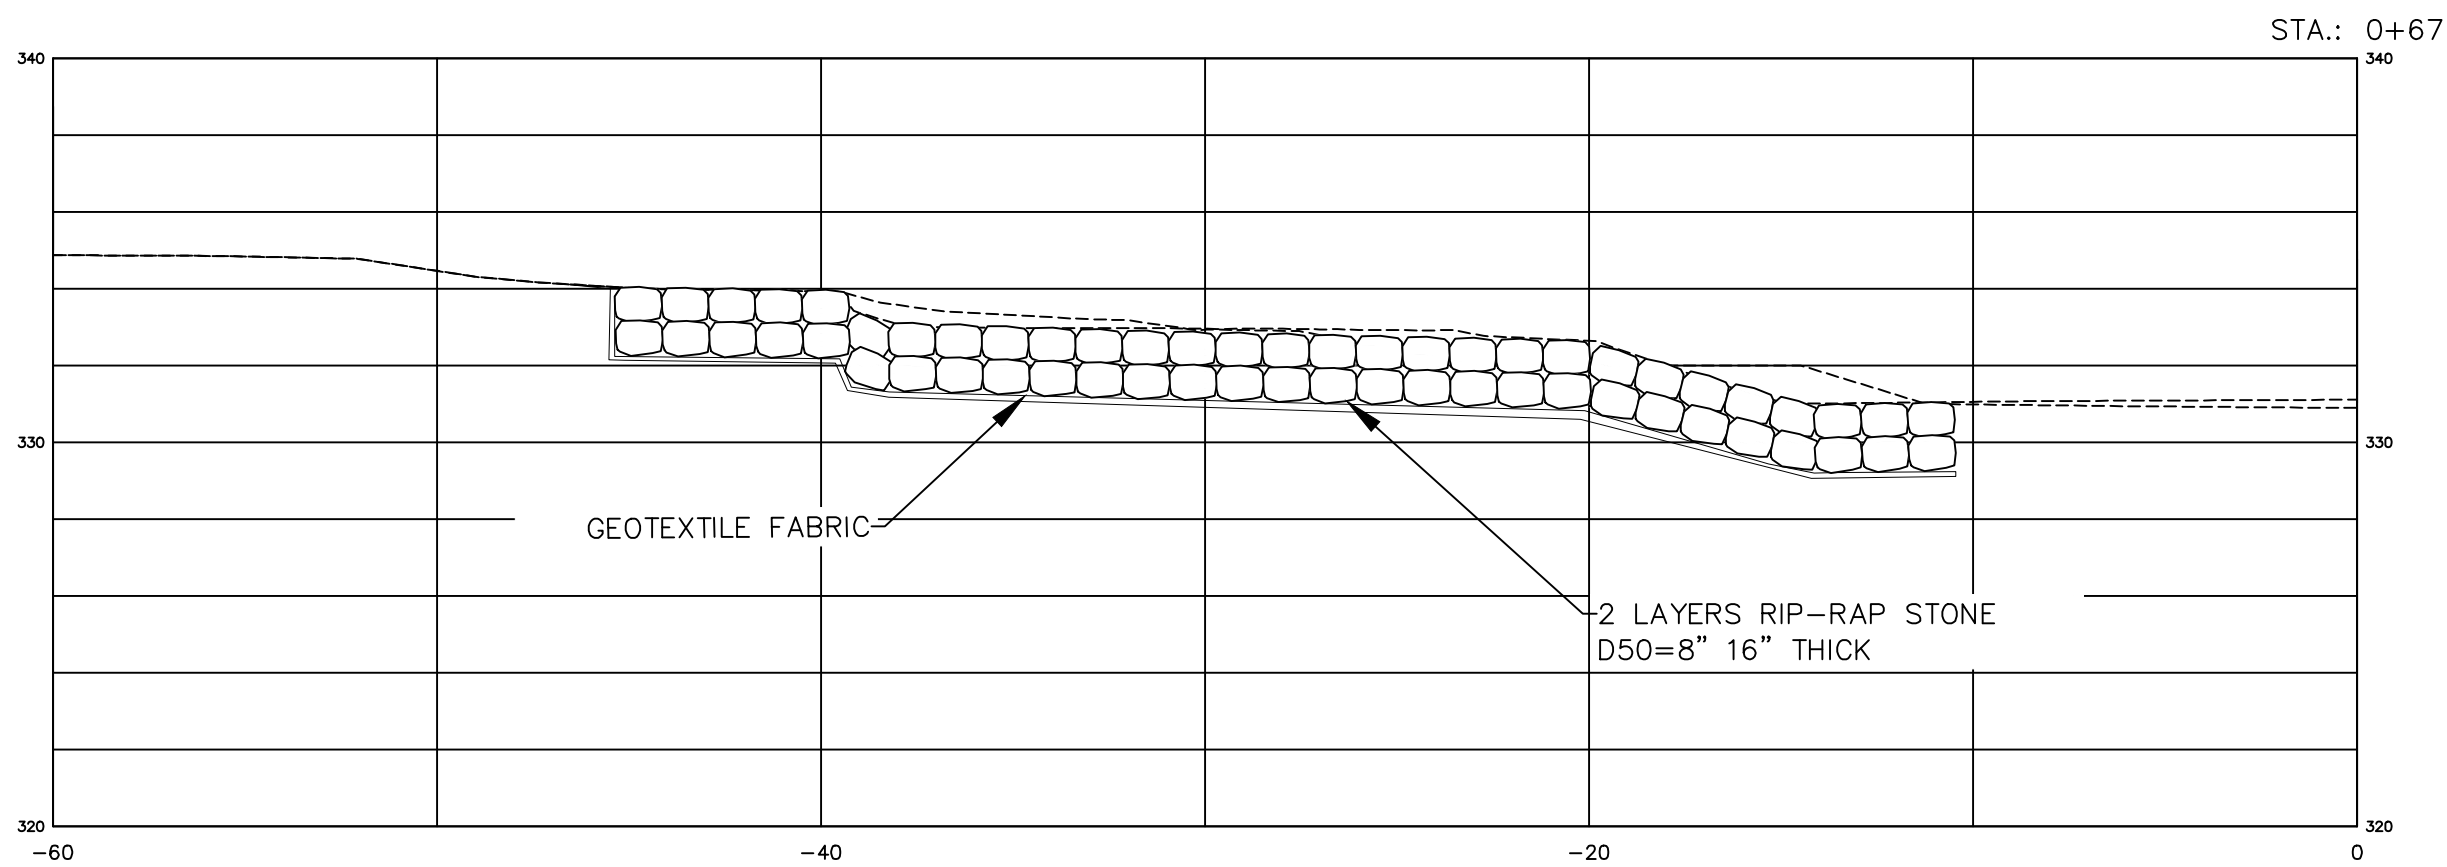
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BANK STABILIZATION ALONG THE PECKMAN RIVER
BLOCK 1703 LOT 54, 55, 56, 59, 60
SWALE CROSS SECTION
TOWNSHIP OF VERONA


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DRAWING NO. VA-102-CP.DWG				SHEET 7	OF 11



LEGEND:

- TOP OF BANK
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- PROPOSED CONTOUR LINES
- LIMIT OF DISTURBANCE
- WATER CENTERLINE
- 150 FEET RIPARIAN ZONE
- EXISTING PAVEMENT BOUNDARY

GRAPHIC SCALE

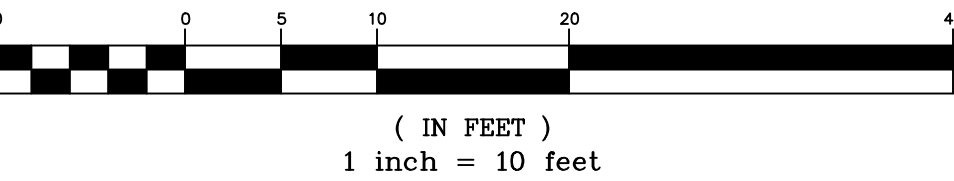


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PROPOSED PLANT SCHEDULE					
KEY	QTY	LATIN NAME	COMMON NAME	SIZE	NOTES
TREES					
SN	4	Salix nigra	Black Willow	2"-2 1/2" Cal	Heavy, Full grown
NS	4	Carya Ovata	Shagbark Hickory	2"-2 1/2" Cal	Heavy, Full grown
PO	4	Platanus occidentalis	Sycamore	2"-2 1/2" Cal	Heavy, Full grown
QR	5	Quercus rubra	Red oak	2"-2 1/2" Cal	Heavy, Full grown
Shrubs					
AS	16	Alnus serrulata	Smooth Alder	2'-3' Tall B & B	3' O.C.
CS	15	Cornus sericea	Redtwig Dogwood	18"-24" 3 Gal	24" O.C.
HV	22	Hamamelis virginiana	Witch Hazel	18"-24" 3 Gal	36" O.C.
AA	22	Amelanchier aboreum	Serviceberry	18"-24" 3 Gal	24" O.C.
VP	16	Viburnum prunifolium	Blackhaw	18"-24" 3 Gal	24" O.C.
AM	15	Aronia arbutifolia	Red Chokeberry	18"-24" 3 Gal	24" O.C.
CR	20	Cornus Racemosa	Grey Dogwood	18"-24" 3 Gal	24" O.C.
VD	16	Viburnum dentatum	Arrowwood	18"-24" 3 Gal	24" O.C.
CR	15	Coreopsis rosea	Rose Coreopsis	18"-24" 3 Gal	24" O.C.

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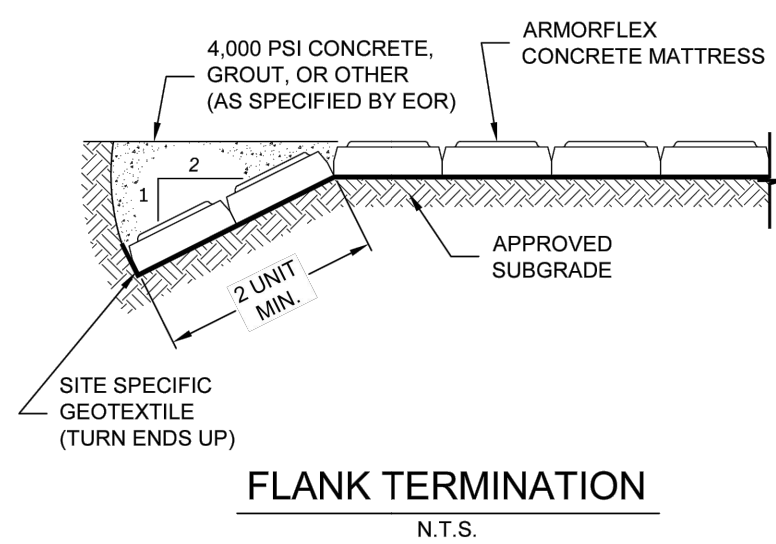
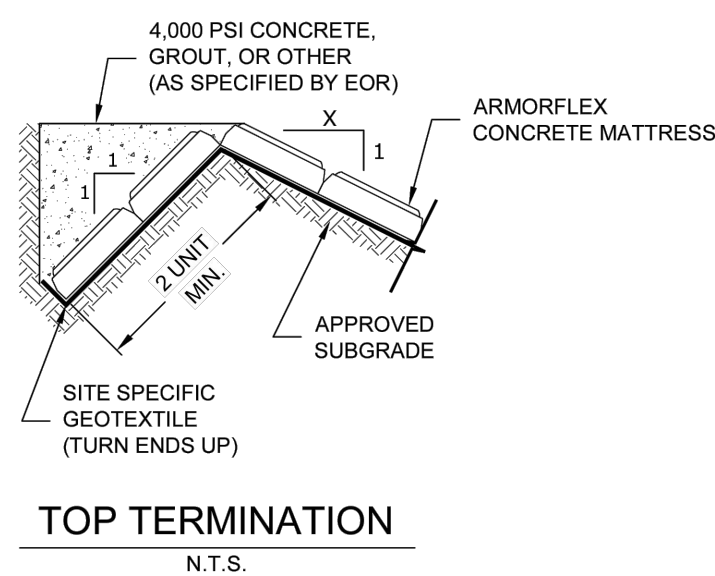
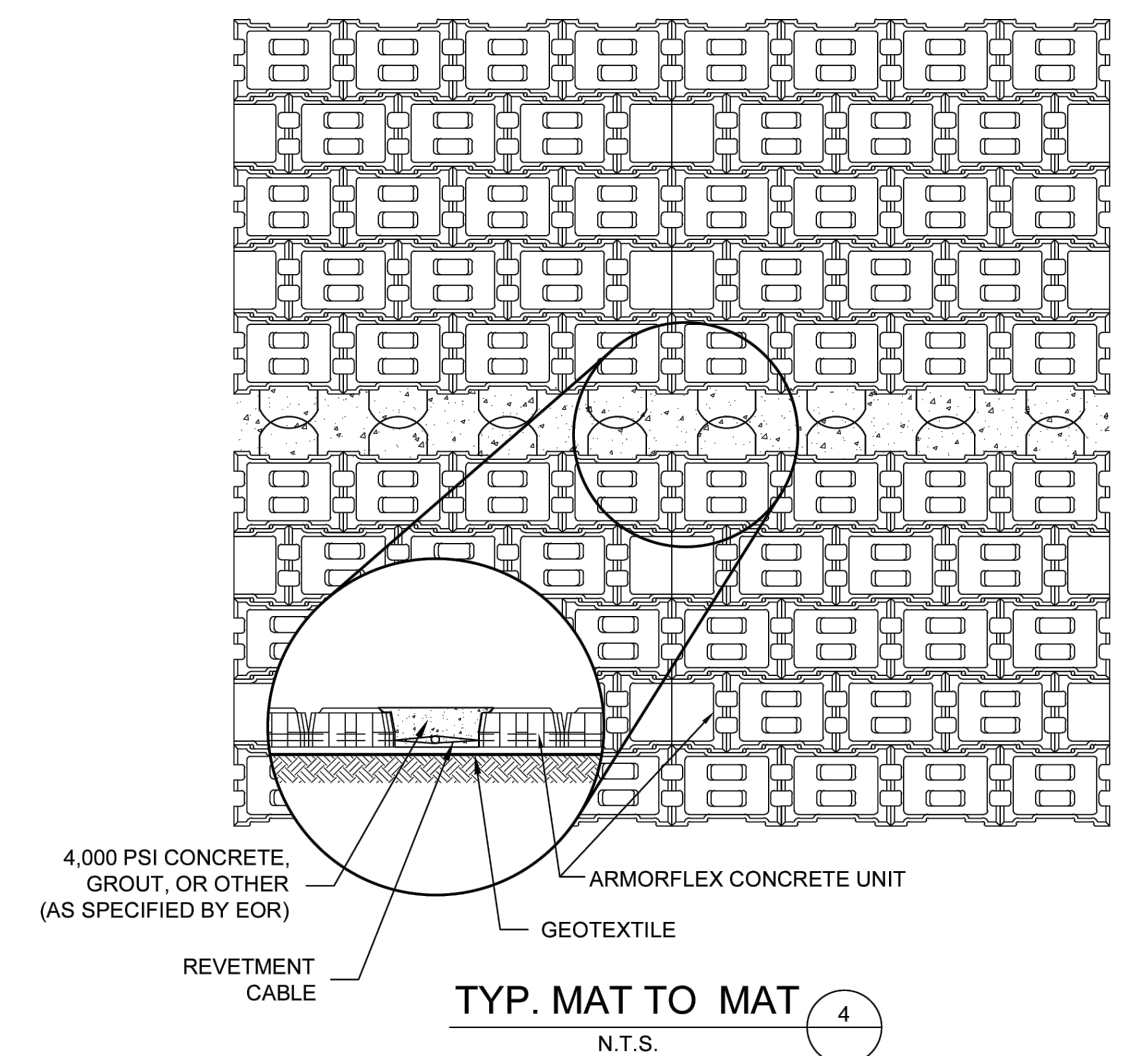
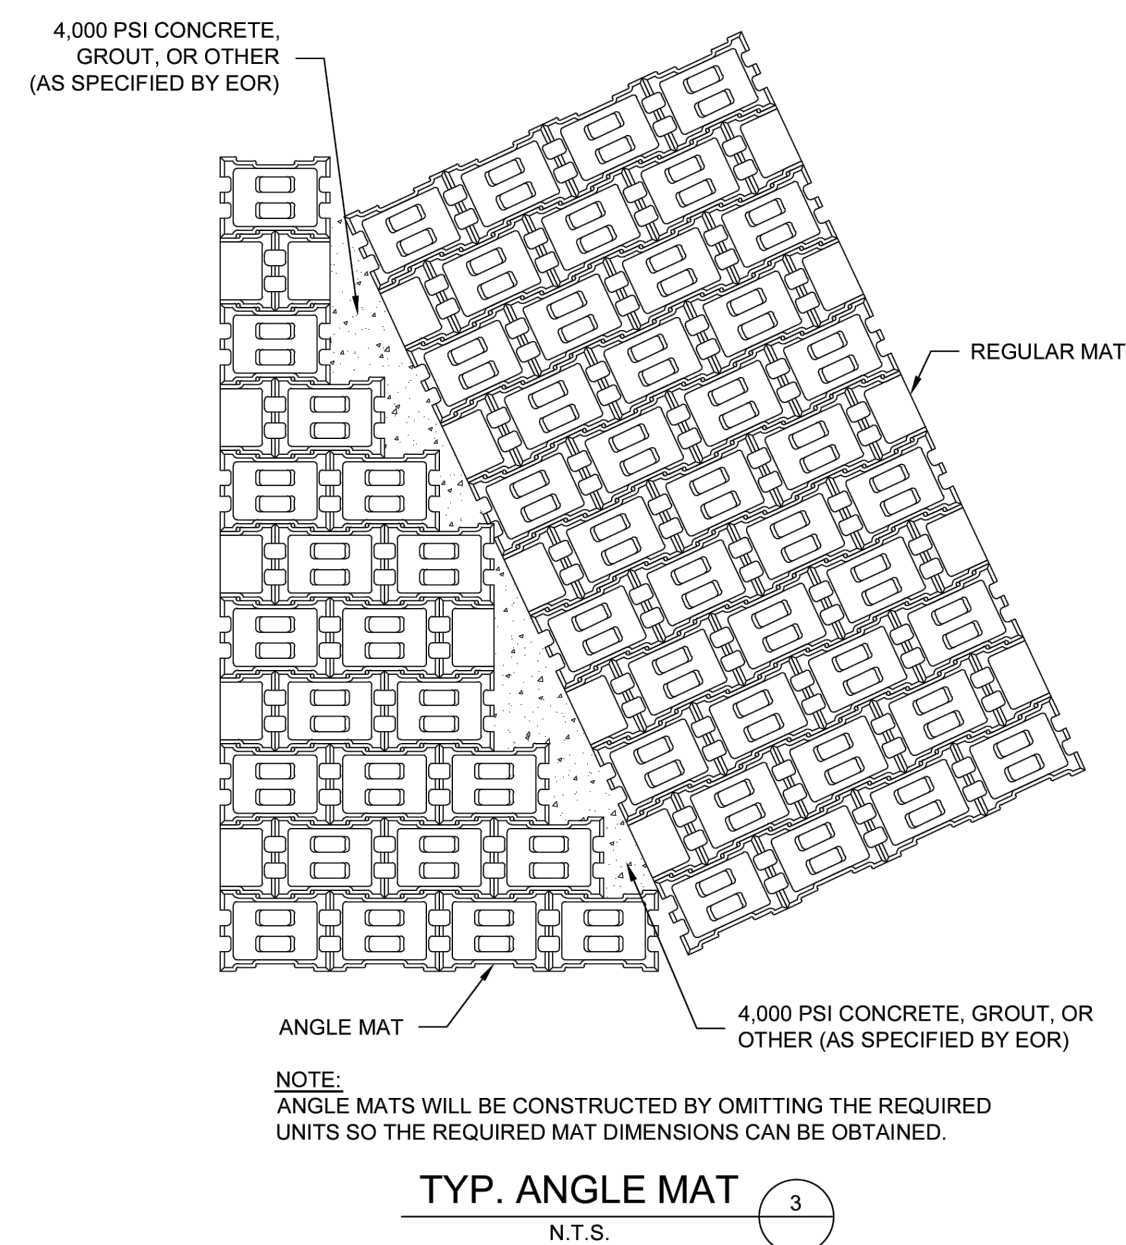
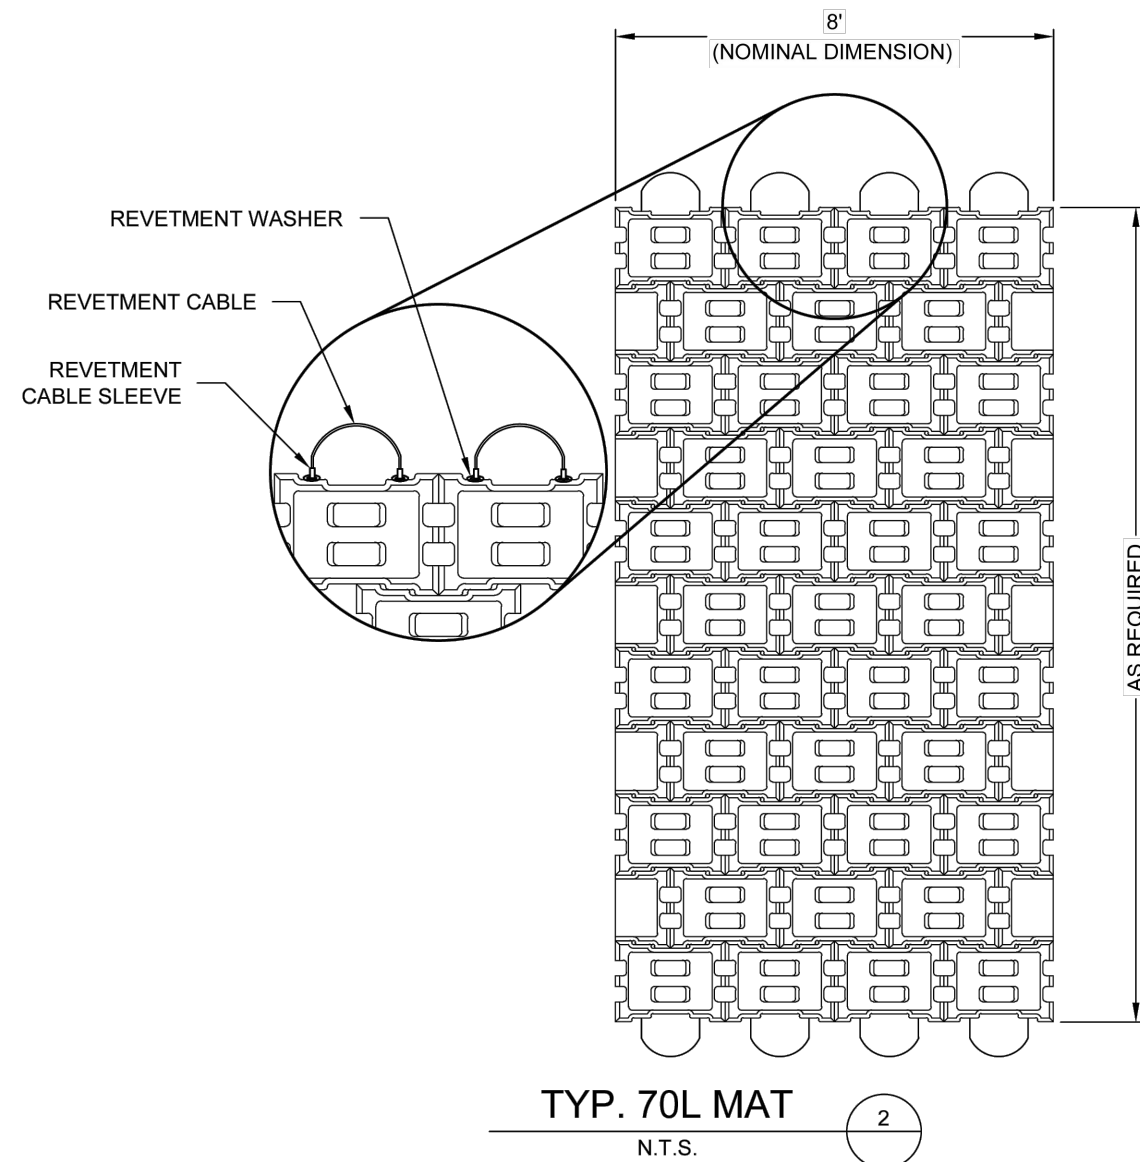
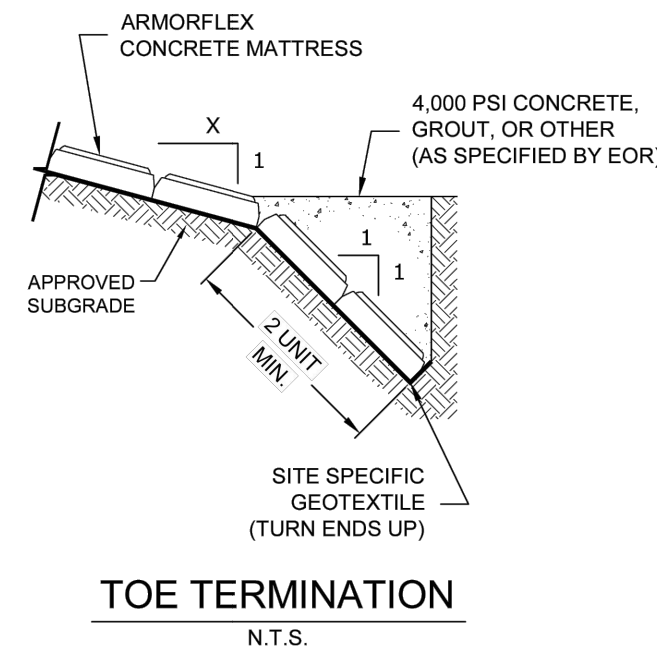
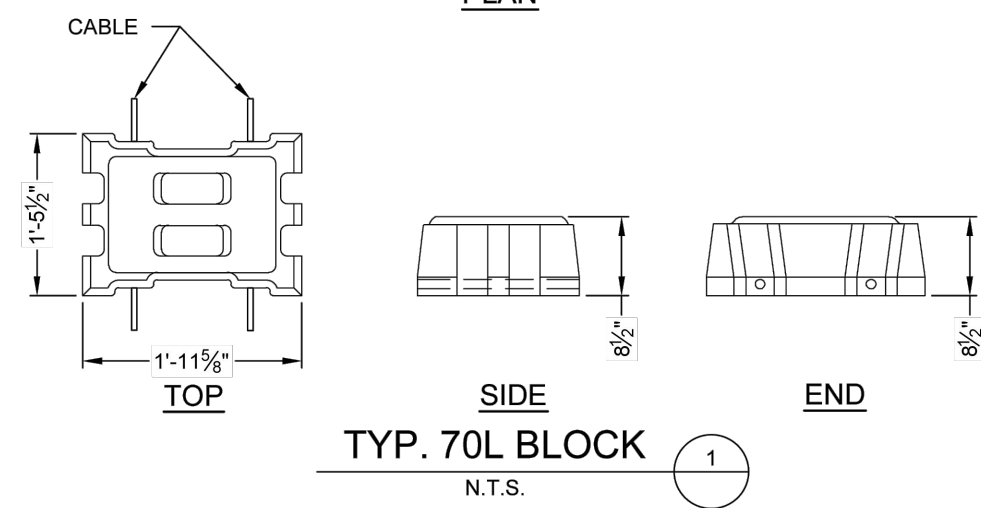
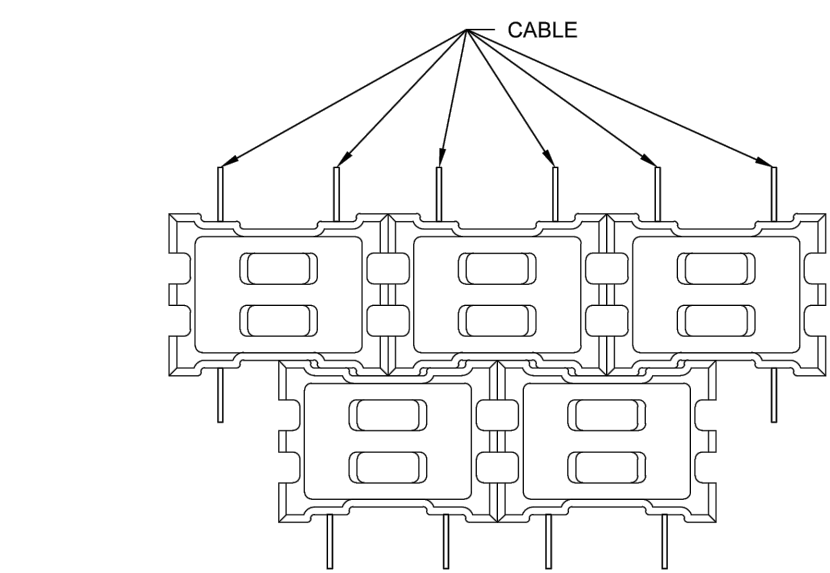
PROFESSIONAL ENGINEER N.J. LIC. 32943

JOSEPH A. POMANTE

PROFESSIONAL ENGINEER N.J. LIC. 43137

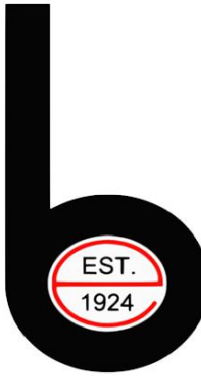BANK STABILIZATION ALONG THE PECKMAN RIVER
BLOCK 1703 LOT 54, 55, 56, 59, 60
PLANTING PLAN
TOWNSHIP OF VERONA

ESSEX COUNTY			NEW JERSEY		
SURVEYED BY DRAWN BY RX	DESIGNED BY SJ CHECKED BY FJR	SCALE: 1" = 10'	JOB NO. VA-102	DATE 10/20/23	
DRAWING NO. VA-102-CP-PLANTING.DWG			SHEET 8 OF 11		




- NOTES:
1. ARTICULATED CONCRETE BLOCK MATTING, OPEN CELL, ARMORFLEX CLASS 70 LARGE, BY CONTECH ENGINEERED SOLUTIONS, LLC, (WEST CHESTER OH) OR APPROVED EQUAL.
 2. NO SEPARATE PAYMENT WILL BE MADE FOR GEOTEXTILE OR CONCRETE UTILIZED FOR TERMINATIONS AS SHOWN ABOVE, BUT THE COST SHALL BE INCLUDED IN THE UNIT PRICE BID FOR ARTICULATED CONCRETE BLOCK MATTING, OPEN CELL.

ARTICULATED CONCRETE BLOCK MATTING, OPEN CELL

N.T.S.

NO.	DATE	DESCRIPTION	SURVEYED BY	DRAWN BY	DESIGNED BY	CHECKED BY

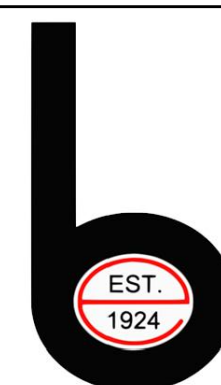

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ENGINEERS - PLANNERS - SURVEYORS - SCIENTISTS

330 PHILLIPS AVENUE, SOUTH HACKENSACK, NJ 07606

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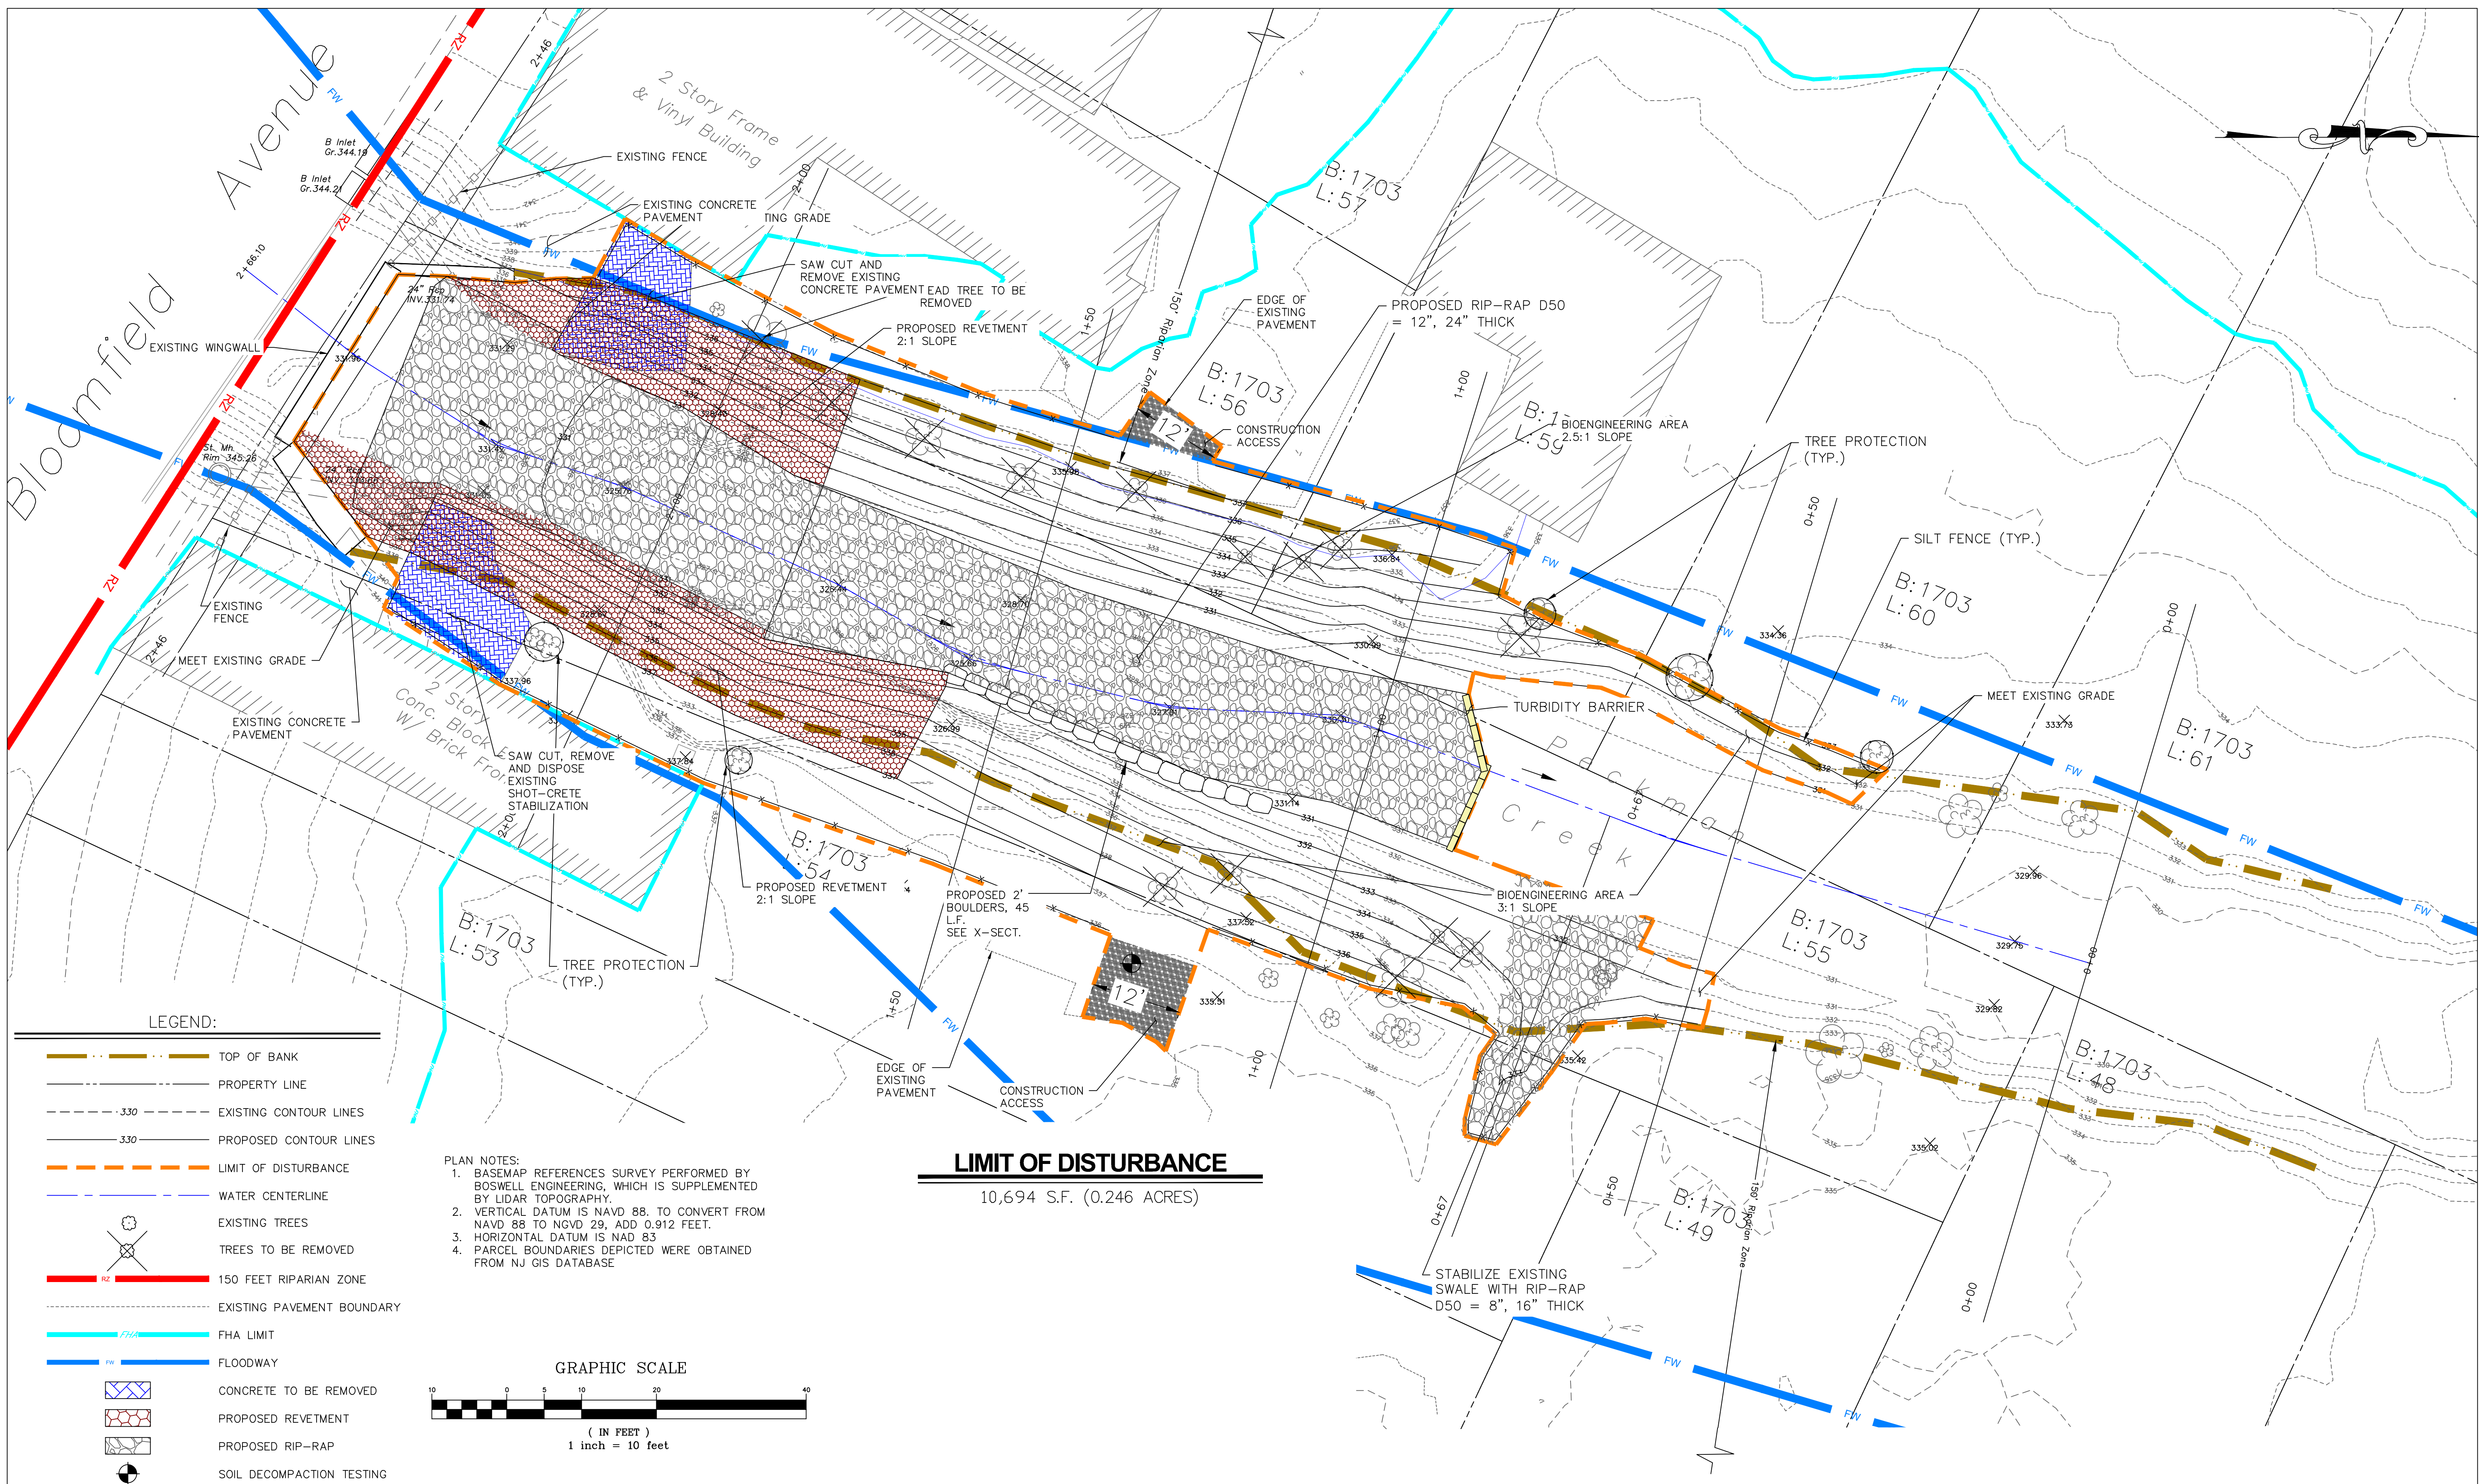
BANK STABILIZATION ALONG THE PECKMAN RIVER

BLOCK 1703 LOT 54, 55, 56, 59, 60


DETAIL SHEET

TOWNSHIP OF VERONA

ESSEX COUNTY			NEW JERSEY		
SURVEYED BY	DESIGNED BY	SCALE:	JOB NO.	DATE	
DRAWN BY RX	CHECKED BY FJR	AS NOTED	VA-102	10/26/23	
DRAWING NO. VA-102-ENV.DWG				SHEET	9 OF 11



3	04/11/25	REVISED PER DEP COMMENTS			RX	RX	FJR		
2	05/07/24	REVISED PER DEP COMMENTS			LLJ	RX	FJR		
1	05/06/24	REVISED PER DEP COMMENTS			LLJ	RX	FJR		
NO.	DATE	DESCRIPTION	SURVEYED BY	DRAWN BY	DESIGNED BY	CHECKED BY			

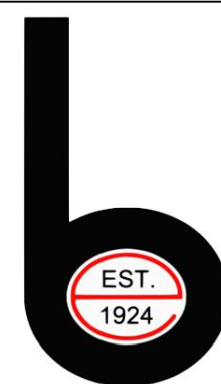

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BANK STABILIZATION ALONG THE PECKMAN RIVER
BLOCK 1703 LOT 54, 55, 56, 59, 60
SOIL EROSION AND SEDIMENT CONTROL PLAN
TOWNSHIP OF VERONA

ESSEX COUNTY			NEW JERSEY		
SURVEYED BY DRAWN BY RX	DESIGNED BY CHECKED BY FJR	SCALE: 1" = 10'	JOB NO. VA-102	DATE 10/26/23	
DRAWING NO. VA-102-SESC.DWG			SHEET 10 OF 11		

3. ALL SOIL EROSION AND SEDIMENT CONTROL PRACTICES ON THIS PLAN WILL BE CONSTRUCTED IN ACCORDANCE WITH THE "NEW JERSEY STANDARDS FOR SOIL EROSION AND SEDIMENT CONTROL," 7TH EDITION LAST REVISED DECEMBER 2017. THESE MEASURES WILL BE INSTALLED PRIOR TO ANY MAJOR SOIL DISTURBANCE OR IN THEIR PROPER SEQUENCE AND MAINTAINED UNTIL PERMANENT PROTECTION IS ESTABLISHED.
4. ALL SOIL TO BE EXPOSED OR STOCKPILED FOR A PERIOD OF GREATER THAN 14 DAYS, AND NOT UNDER ACTIVE CONSTRUCTION, WILL BE TEMPORARILY SEEDED AND HAY MULCHED OR OTHERWISE PROVIDED WITH VEGETATIVE COVER. THIS TEMPORARY COVER SHALL BE MAINTAINED UNTIL SUCH TIME WHEREBY PERMANENT RESTABILIZATION IS ESTABLISHED.
5. SEEDING DATES: THE FOLLOWING SEEDING DATES ARE BEST RECOMMENDED TO ESTABLISH PERMANENT VEGETATIVE COVER WITHIN MOST LOCATIONS IN THE HEPSCD: SPRING - 3/1 TO 5/15 AND FALL - 8/15 TO 10/01.
6. SEDIMENT FENCES ARE TO BE PROPERLY TRENCHED AND MAINTAIN UNTIL PERMANENT VEGETATIVE COVER IS ESTABLISHED.
7. ALL STORM DRAINAGE INLETS SHALL BE PROTECTED BY ONE OF THE PRACTICES ACCEPTED IN THE STANDARDS AND PROTECTION SHALL REMAIN UNTIL PERMANENT STABILIZATION HAS BEEN ESTABLISHED. STORM DRAINAGE OUTLET POINTS SHALL BE PROTECTED AS REQUIRED BEFORE THEY BECOME FUNCTIONAL.
8. MULCH MATERIALS SHALL BE UN-ROTTED SMALL GRAIN STRAW APPLIED AT THE RATE OF 70-90 POUNDS PER 1,000 SQUARE FEET AND ANCHORED WITH A MULCH ANCHORING TOOL, LIQUID MULCH BINDERS, OR NETTING THE DOWN. OTHER SUITABLE MATERIALS MAY BE USED IF APPROVED BY THE SOIL CONSERVATION DISTRICT.
9. ALL EROSION CONTROL DEVICES SHALL BE PERIODICALLY INSPECTED, MAINTAINED AND CORRECTED BY THE CONTRACTOR. ANY DAMAGE INCURRED BY EROSION SHALL BE RECTIFIED IMMEDIATELY.
10. THE HUDSON-ESSEX-PASSAIC SOIL CONSERVATION DISTRICT WILL BE NOTIFIED IN WRITING AT LEAST 48 HOURS PRIOR TO ANY SOIL DISTURBING ACTIVITIES. FAX - (862) 333-4507, EMAIL - INFORMATION@HEPSCD.ORG.
11. THE APPLICANT MUST OBTAIN A DISTRICT ISSUED REPORT-OF-COMPLIANCE PRIOR TO APPLYING FOR THE CERTIFICATE OF OCCUPANCY OR TEMPORARY CERTIFICATE OF OCCUPANCY FROM THE RESPECTIVE MUNICIPALITY, NJ-DCA OR ANY OTHER CONTROLLING AGENCY. CONTACT THE DISTRICT AT 862-333-4505 TO REQUEST A FINAL INSPECTION, GIVING ADVANCED NOTICE UPON COMPLETION OF THE RESTABILIZATION MEASURES. A PERFORMANCE DEPOSIT MAY BE POSTED WITH THE DISTRICT WHEN WINTER WEATHER OR SNOW COVER PROHIBITS THE PROPER APPLICATION OF SEED, MULCH, FERTILIZER OR HYDRO-SEED.
12. PAVED ROADSWAYS MUST BE KEPT CLEAN AT ALL TIMES. DO NOT UTILIZE A FIRE OR GARDEN HOSE TO CLEAN ROADS UNLESS THE RUNOFF IS DIRECTED TO A PROPERLY DESIGNATED AND FUNCTIONING SEDIMENT BASIN. WATER PUMPED OUT OF THE EXCAVATED AREAS CONTAINS SEDIMENTS THAT MUST BE REMOVED PRIOR TO DISCHARGING TO RECEIVING BODIES OF WATER USING REMOVABLE PUMPING STATIONS, SUMP PITS, PORTABLE SEDIMENTATION TANKS AND/OR SILT CONTROL BAGS.
13. ALL SURFACES HAVING LAWN OR LANDSCAPING AS FINAL COVER ARE TO BE PROVIDED TOPSOIL PRIOR TO RE-SEEDING, SODDING OR PLANTING. A DEPTH OF 5.0 INCHES, FIRMED IN PLACE, IS REQUIRED, AS PER THE STANDARDS FOR TOPSOILING AND LAND GRADING, LAST REVISED DECEMBER, 2017.
14. ALL PLAN REVISIONS MUST BE SUBMITTED TO THE DISTRICT FOR PROPER REVIEW AND APPROVAL.
15. A CRUSHED STONE WHEEL CLEANING TRACKING-PAD IS TO BE INSTALLED AT ALL SITE EXITS USING 2-1/2" - 1" CRUSHED ANGULAR STONE (ASTM 2 OR 3) TO A MINIMUM LENGTH OF 50 FEET AND MINIMUM DEPTH OF 6". ALL DRIVEWAYS MUST BE PROVIDED WITH CRUSHED STONE UNTIL PAVING IS COMPLETE.
16. STEEP SLOPES INCURRING DISTURBANCE MAY REQUIRE ADDITIONAL STABILIZATION MEASURES. THESE "SPECIAL" MEASURES SHALL BE DESIGNED BY THE APPLICANT'S ENGINEER AND BE APPROVED BY THE SOIL CONSERVATION DISTRICT.
17. THE HUDSON-ESSEX-PASSAIC SOIL CONSERVATION DISTRICT SHALL BE NOTIFIED, IN WRITING, FOR THE SALE OF ANY PORTION OF THE PROJECT OR FOR THE SALE OF INDIVIDUAL LOTS. NEW OWNERS' INFORMATION SHALL BE PROVIDED. ADDITIONAL MEASURES DEEMED NECESSARY BY DISTRICT OFFICIALS SHALL BE IMPLEMENTED AS CONDITIONS WARRANT.

1. THE CONTRACTOR SHALL FURNISH AND PLANT ALL PLANTS SHOWN ON THE DRAWINGS, AS SPECIFIED, AND IN QUANTITIES INDICATED ON THE PLANT LIST.
2. ALL PLANTS SHALL BE NURSERY GROWN, AND HAVE A MEASUREMENT AND SIZE IN ACCORDANCE WITH THE AMERICAN STANDARD FOR NURSERY STOCK, LATEST EDITION AS PUBLISHED BY AMERICAN HORT. ONLY NURSERY GROWN PLANT MATERIALS SHALL BE ACCEPTABLE.
3. ALL PLANTS SHALL BE TYPICAL OF THEIR SPECIES OR VARIETY AND SHALL HAVE A NORMAL OR HEAVY HABIT OR GROWTH. THEY SHALL BE SOUND, HEALTHY AND VIGOROUS, WELL BRANCHED AND DENSELY FOLIATED WHEN IN LIFE. THEY SHALL BE FREE OF DISEASE AND INSECT PESTS, EGGS OR LARVAE. THEY SHALL HAVE HEALTHY WELL-DEVELOPED ROOT SYSTEMS.
4. SUBSTITUTIONS: WHEN PLANTS OF A SPECIFIC KIND OR SIZE ARE NOT AVAILABLE WITHIN A REASONABLE DISTANCE, SUBSTITUTIONS MAY BE MADE UPON REQUEST BY THE CONTRACTOR IN WRITING, IF APPROVED BY THE OWNER OR HIS REPRESENTATIVE & THE MUNICIPALITY. THE CONTRACTOR SHALL NOTIFY THE OWNER IN WRITING OF ANY PLANT MATERIALS WHICH HE FEELS WILL NOT BE AVAILABLE OR LIKELY TO THRIVE IN THE LOCATION INDICATED ON THE PLAN. PRIOR TO SUBMITTING A BID ON THIS PROJECT, SUBSTITUTIONS MUST BE APPROVED BY THE MUNICIPAL ENGINEER.
5. BALLED AND BURLAPPED PLANTS SHALL BE DUG WITH FULL FIBRIOUS BALLS OF EARTH, OF DIAMETER AND DEPTH TO INCLUDE MOST OF THE FIBROUS ROOTS. CONTAINER GROWN STOCK SHALL HAVE BEEN GROWN IN A CONTAINER LONG ENOUGH FOR THE ROOT SYSTEM TO HAVE DEVELOPED SUFFICIENTLY TO HOLD ITS SOIL TOGETHER FIRM AND WHOLE. NO PLANTS SHALL BE LOOSE IN THE CONTAINER.
6. MULCH FOR TREES, SHRUBS AND GROUND COVER SHALL BE DOUBLE-SHREDDED. A HARDWOOD MULCH, OWNER TO CORM COLOR: AGED AT LEAST ONE YEAR, CLEAR AND FREE OF WEEDS. PRE-EMERGENT WEED KILLER SHALL BE "TREFLAN" OR APPROVED EQUAL. APPLY WEEK KILLER TO TOPSOIL, PRIOR TO MULCHING BED PLANTINGS. ALL SHRUBS TO BE PLANTED IN CONTINUOUS BEDS UNLESS OTHERWISE NOTED. ALL SHRUB BEDS TO RECEIVE 3" DEEP CONTINUOUS MULCH COVER. MULCH MAY NOT TOUCH THE TRUNKS OF TREES OR THE MAIN STEMS OF SHRUBS.
7. PREPARATION OF BACKFILL & PLANTING SOIL - BEFORE MIXING, CLEAN TOPSOIL OF ACIDIC MARL, STICKS, ROOTS, PLANTS, TRASH, LARGE STONES, CLAY, LUMPS AND OTHER EXTRANEOUS MATERIALS HARMFUL OR TOXIC TO PLANT GROWTH. SOIL, (BACKFILL) FOR TREES, SHRUBS AND GROUND COVER SHALL BE MIXTURE BY VOLUME OF THE FOLLOWING MATERIALS IN QUANTITIES SPECIFIED: 1 PART PEAT MOSS TO 5 PARTS TOPSOIL.
8. ALL PLANTS SHALL BE AT THE LOCATIONS INDICATED ON THE DRAWINGS. THE CONTRACTOR SHALL BE RESPONSIBLE FOR PLANTING AT THE CORRECT GRADES, ALIGNMENT, AND TO THE INDICATED LAYOUT OF PLANTING BEDS.
9. THE CONTRACTOR SHALL LAYOUT WITH IDENTIFIABLE STAKES INDIVIDUAL TREES AND SHRUB LOCATIONS AND AREAS FOR MULTIPLE PLANTING ALONG WITH THE ARRANGEMENTS AND OUTLINE OF PLANTING BEDS AS INDICATED ON THE DRAWINGS, FOR APPROVAL BY THE OWNER'S REPRESENTATIVE PRIOR TO EXCAVATION OF PLANTING PITS OR BEDS. AT LEAST THREE BUSINESS DAYS IS TO BE GIVEN TO PERMIT REVIEW AND APPROVAL OF PLANT LOCATIONS. DO NOT PROCEED WITH PLANTING WORK UNTIL APPROVAL IS GIVEN IN WRITING.
10. TOPSOIL SHALL BE INSTALLED BY THE CONTRACTOR AT A THICKNESS OF APPROXIMATELY FIVE (5) INCHES. CONTRACTOR IS RESPONSIBLE TO SUPPLY ALL TOPSOIL REQUIRED FOR BACKFILL MIXTURE.
11. THE PLANT ROOT BALL AND PREPARATION HOLE FOR BACKFILL MUST HAVE A WIDTH AT LEAST 1 FOOT GREATER THAN THE WIDTH OF THE ROOT BALL AND HAVE A DEPTH OF AT LEAST 6" MORE THAN THE HEIGHT OF THE ROOT BALL AS NOTED IN EACH TREE PLANTING DETAIL.

1. AN IRRIGATION SYSTEM WILL NOT BE PROVIDED ON SITE. AS WATERING IS A PRIMARY CONCERN FOR PLANT SURVIVAL THROUGHOUT THE ESTABLISHMENT & GUARANTEE PERIOD, FOR EACH CATEGORY OF PLANT; EVERGREEN OR CONIFEROUS TREES, DECIDUOUS SHADE TREES, DECIDUOUS ORNAMENTAL TREES, AND FOR SHRUBS THE RECOMMENDED WATERING REQUIREMENTS ARE AS FOLLOWS:

- A. SHRUBS 15 MINUTES / 1 TIME PER WEEK (± 1 GAL.)
- B. CONIFERS/EVERGREENS 30 MINUTES / 1 TIME PER WEEK (± 4-5 GAL.)
- C. ORNAMENTAL TREES 30 MINUTES / 1 TIME PER WEEK (± 4-5 GAL.)
- D. SHADE TREES 30 MINUTES / 1 TIME PER WEEK (± 4-5 GAL.)

IMPLEMENTATION OF SOIL EROSION AND SEDIMENT CONTROL MEASURES	4 WEEKS
CLEAR CONCRETE SURFACE AND RIP-RAP	1 WEEK
CONSTRUCT BOULDERS ROW AND RESTORE CHANNEL	3 WEEKS
FINAL GRADING	1 WEEK
ESTABLISH FINAL VEGETATIVE COVER	1 WEEK
REMOVE SOIL EROSION MEASURES	1 WEEK
	<hr/> 11 WEEKS

SOIL COMPACTION TESTING REQUIREMENTS

- NOTE: ADDITIONAL TESTING METHODS WHICH CONFORM TO ASTM STANDARDS AND SPECIFICATIONS, AND WHICH PRODUCE A DRY WEIGHT, SOIL BULK DENSITY MEASUREMENT MAY BE ALLOWED SUBJECT TO DISTRICT APPROVAL.
- SOIL COMPACTION TESTING IS NOT REQUIRED IF/WHEN SUBSOIL COMPACTION REMEDIATION (SCARIFICATION/TILLAGE (6" MINIMUM DEPTH) OR SIMILAR) IS PROPOSED AS PART OF THE SEQUENCE OF CONSTRUCTION.

PROCEDURES SHALL BE USED TO MITIGATE EXCESSIVE SOIL COMPACTION PRIOR TO PLACEMENT OF TOPSOIL AND ESTABLISHMENT OF PERMANENT VEGETATIVE COVER.

RESTORATION OF COMPACTED SOILS SHALL BE THROUGH DEEP SCARIFICATION/TILLAGE (6" MINIMUM DEPTH) WHERE THERE IS NO DANGER TO UNDERGROUND UTILITIES (CABLES, IRRIGATION SYSTEMS, ETC.). IN THE ALTERNATIVE, ANOTHER METHOD AS SPECIFIED BY A NEW JERSEY LICENSED PROFESSIONAL ENGINEER MAYBE SUBSTITUTED SUBJECT TO DISTRICT APPROVAL.

PROBING WIRE TEST- 15.5 GA STEEL WIRE (SURVEY FLAG)

NOTE: SOIL SHOULD BE MOIST BUT NOT SATURATED. DO NOT TEST WHEN SOIL IS EXCESSIVELY DRY OR SUBJECT TO FREEZING TEMPERATURES. SLOW, STEADY DOWNWARD PRESSURE USED TO ADVANCE THE WIRE.

WIRE MAY BE RE-INSERTED
IF AN OBSTRUCTION (ROCK,
DEBRIS) IS ENCOUNTERED


HANDHELD SOIL PENETROMETER TEST

NOTE: SOIL SHOULD BE MOIST BUT NOT SATURATED. DO NOT TEST WHEN SOIL IS EXCESSIVELY DRY OR SUBJECT TO FREEZING TEMPERATURES. SLOW STEADY DOWNWARD PRESSURE USED TO ADVANCE THE PROBE. PROBE MUST PENETRATE AT LEAST 6" WITH LESS THAN 300 PSI READING ON THE GAGE.

PENETROMETER MAY BE RE-INSERTED IF/WHEN AN OBSTRUCTION (ROCK, ROOT, DEBRIS) IS ENCOUNTERED

6" MIN. VISIBLE MARK ON WIRE AT DEPTH

* USE CORRECT SIZE TIP FOR SOIL TYPE

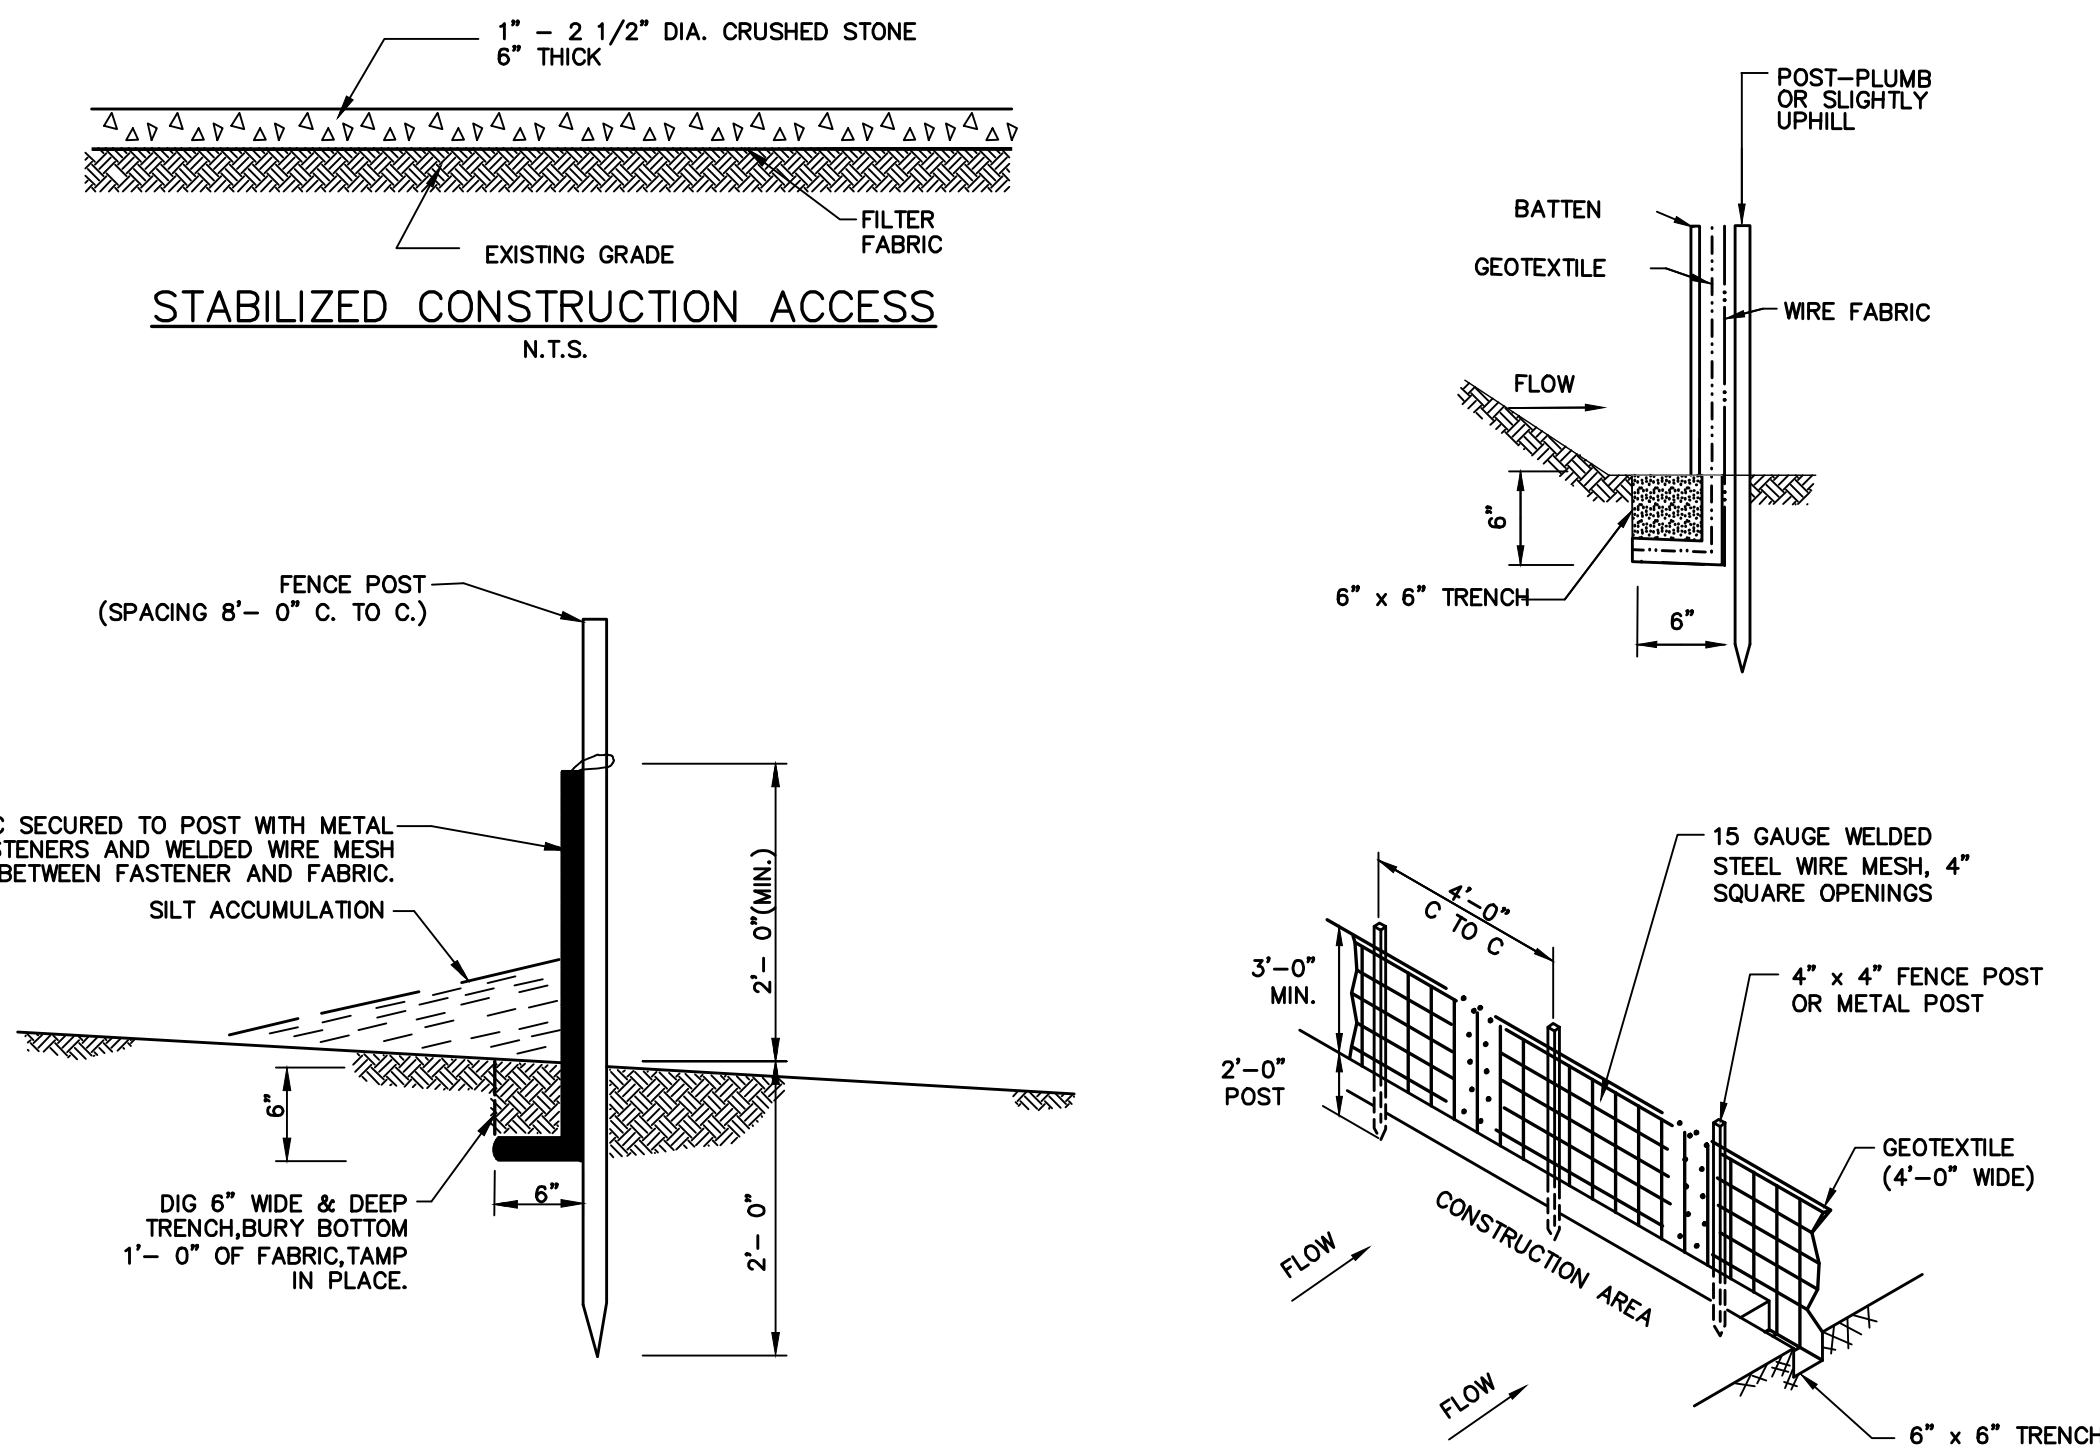

NOTES:

1. SECURELY FASTEN GEOTEXTILE TO WIRE FABRIC BY USE OF WIRE TIES OR HOG RINGS, THEN SANDWICH BETWEEN A 1" X 3" X 3' BATTEN AND THE POSTS PLACING SCREWS AT 6 INCH INTERVALS STARTING 3 INCHES FROM TOP.
2. BURY 4" X 4" FENCE POST 2'-0" BELOW GROUND.
3. BURY BOTTOM 1 FOOT OF GEOTEXTILE AS PER SILT FENCE AND TAMP IN PLACE.
4. SECURELY FASTEN ENDS OF INDIVIDUAL ROLLS OF GEOTEXTILE TO A COMMON POST BY WRAPPING EACH END OF THE GEOTEXTILE AROUND A BATTEN TWICE AND ATTACHING THE BATTEN TO POST WITH SCREWS AT 6 INCH INTERVALS STARTING 3 INCHES FROM THE TOP. SPLICING OF INDIVIDUAL ROLLS SHALL NOT OCCUR AT LOW POINTS
5. BURY 6" OF WIRE FABRIC IN TIDAL AREAS.

PLANT MIXTURE

1/4" NYLON OR MANILA ROPE FORMS REINFORCEMENT AIDS IN REMOVAL OR RELOCATION OF BARRIER BY SERVING AS A PICK-UP LINE FOR WEIGHTS. ROPES AND WEIGHTS ARE TO BE ATTACHED TO END FLOATS AND EVERY SECOND FLOAT BETWEEN END FLOATS.

FRONT VIEW

100' SECTION

FLOATS

5' 5'

WATER SURFACE

BRASS GROMMET

GROMMETS AT 2' C.C. TO CONNECT SECTIONS.

3" FOLD SAME TYPE AS TOP AND BOTTOM FOLD

1' ±

10 MIL. POLYETHYLENE PLASTIC SHEET OR SUITABLE ALTERNATE TO FIT EXISTING CONDITION AS APPROVED BY THE ENGINEER.

REQUIRED SPECIFIC LOCATION VARIES AS

10' ±

WEIGHT 5# ±

BOTTOM

SIDE VIEW FOLDING DETAIL

FOLD TOP AND BOTTOM TO GET FOUR THICKNESSES OF MATERIAL

TYPICAL APPLICATION

STREAM

DISCHARGE POINT

SHORE LINE OR DIKE

50°

BODY OF WATER DISCHARGE POINT

TYPICAL APPLICATION

SUBMARINE CABLE

WET EXCAVATION OR BRIDGE STRUCTURE. (WET)

GENERAL NOTES:

PLACE SILT BARRIER TO PREVENT DRIFTING OF SILT CAUSED BY DISCHARGE OF STORM SEWERS DURING CONSTRUCTION, DREDGING OR FILLING OPERATIONS.

EXACT PLACEMENT OF SILT BARRIER SHALL BE SO AS TO EFFECTIVELY CONTROL SILT DISPERSION UNDER THE CONDITIONS PRESENT ON A PARTICULAR PROJECT.

THE DETAILS SHOWN ON THIS SHEET ARE SUGGESTED METHODS ONLY. ALTERNATE SOLUTION AND USAGE OF MATERIALS MAY BE USED AS APPROVED.

SECTION A-A

1/4" NYLON OR MANILA ROPE TO BE LACK IN FINAL POSITION

FLOATS

3/8" DIA. ALUM. ROD

COTTER PIN THRU ROD

BRASS GROMMET

PLASTIC SHEET OR ALTERNATE

BRASS GROMMET

HOOK (CLOSE TO PREVENT LOSS)

WEIGHT

SILPKNOT TOP & BOTTOM

NOTE:

SUITABLE ALTERNATE MAY BE FASTENED TO STAKES DRIVEN INTO THE BOTTOM IN LIEU OF FLOATS AND WEIGHTS

POMANTE	N.T.S. BANK STABILIZATION ALONG THE PECKMAN RIVER BLOCK 1703 LOT 54, 55, 56, 59, 60 SOIL EROSION AND SEDIMENT CONTROL DETAILS TOWNSHIP OF VERONA												
ER N.J. LIC. 43137	<table style="width: 100%; border: none;"> <tr> <td style="width: 45%; text-align: center; border-bottom: 1px solid black;">ESSEX COUNTY</td> <td style="width: 55%; text-align: right; border-bottom: 1px solid black;">NEW JERSEY</td> </tr> <tr> <td style="border: 1px solid black; padding: 2px; text-align: center;"> SURVEYED BY DRAWN BY RX </td> <td style="border: 1px solid black; padding: 2px; text-align: center;"> DESIGNED BY SJ CHECKED BY FJR </td> <td style="border: 1px solid black; padding: 2px; text-align: center;"> SCALE: AS NOTED </td> <td style="border: 1px solid black; padding: 2px; text-align: center;"> JOB NO. VA-102 </td> <td style="border: 1px solid black; padding: 2px; text-align: center;"> DATE 10/20/23 </td> </tr> <tr> <td colspan="4" style="border: none; padding-top: 5px;"> DRAWING NO. VA-102-SESC.DWG </td> <td style="border: none; text-align: right; padding-top: 5px;"> SHEET 11 OF 11 </td> </tr> </table>	ESSEX COUNTY	NEW JERSEY	SURVEYED BY DRAWN BY RX	DESIGNED BY SJ CHECKED BY FJR	SCALE: AS NOTED	JOB NO. VA-102	DATE 10/20/23	DRAWING NO. VA-102-SESC.DWG				SHEET 11 OF 11
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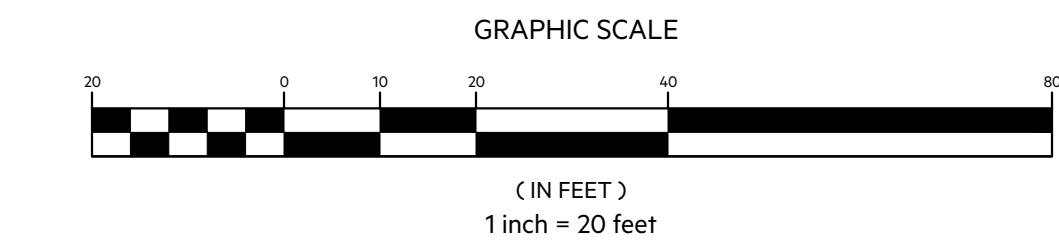
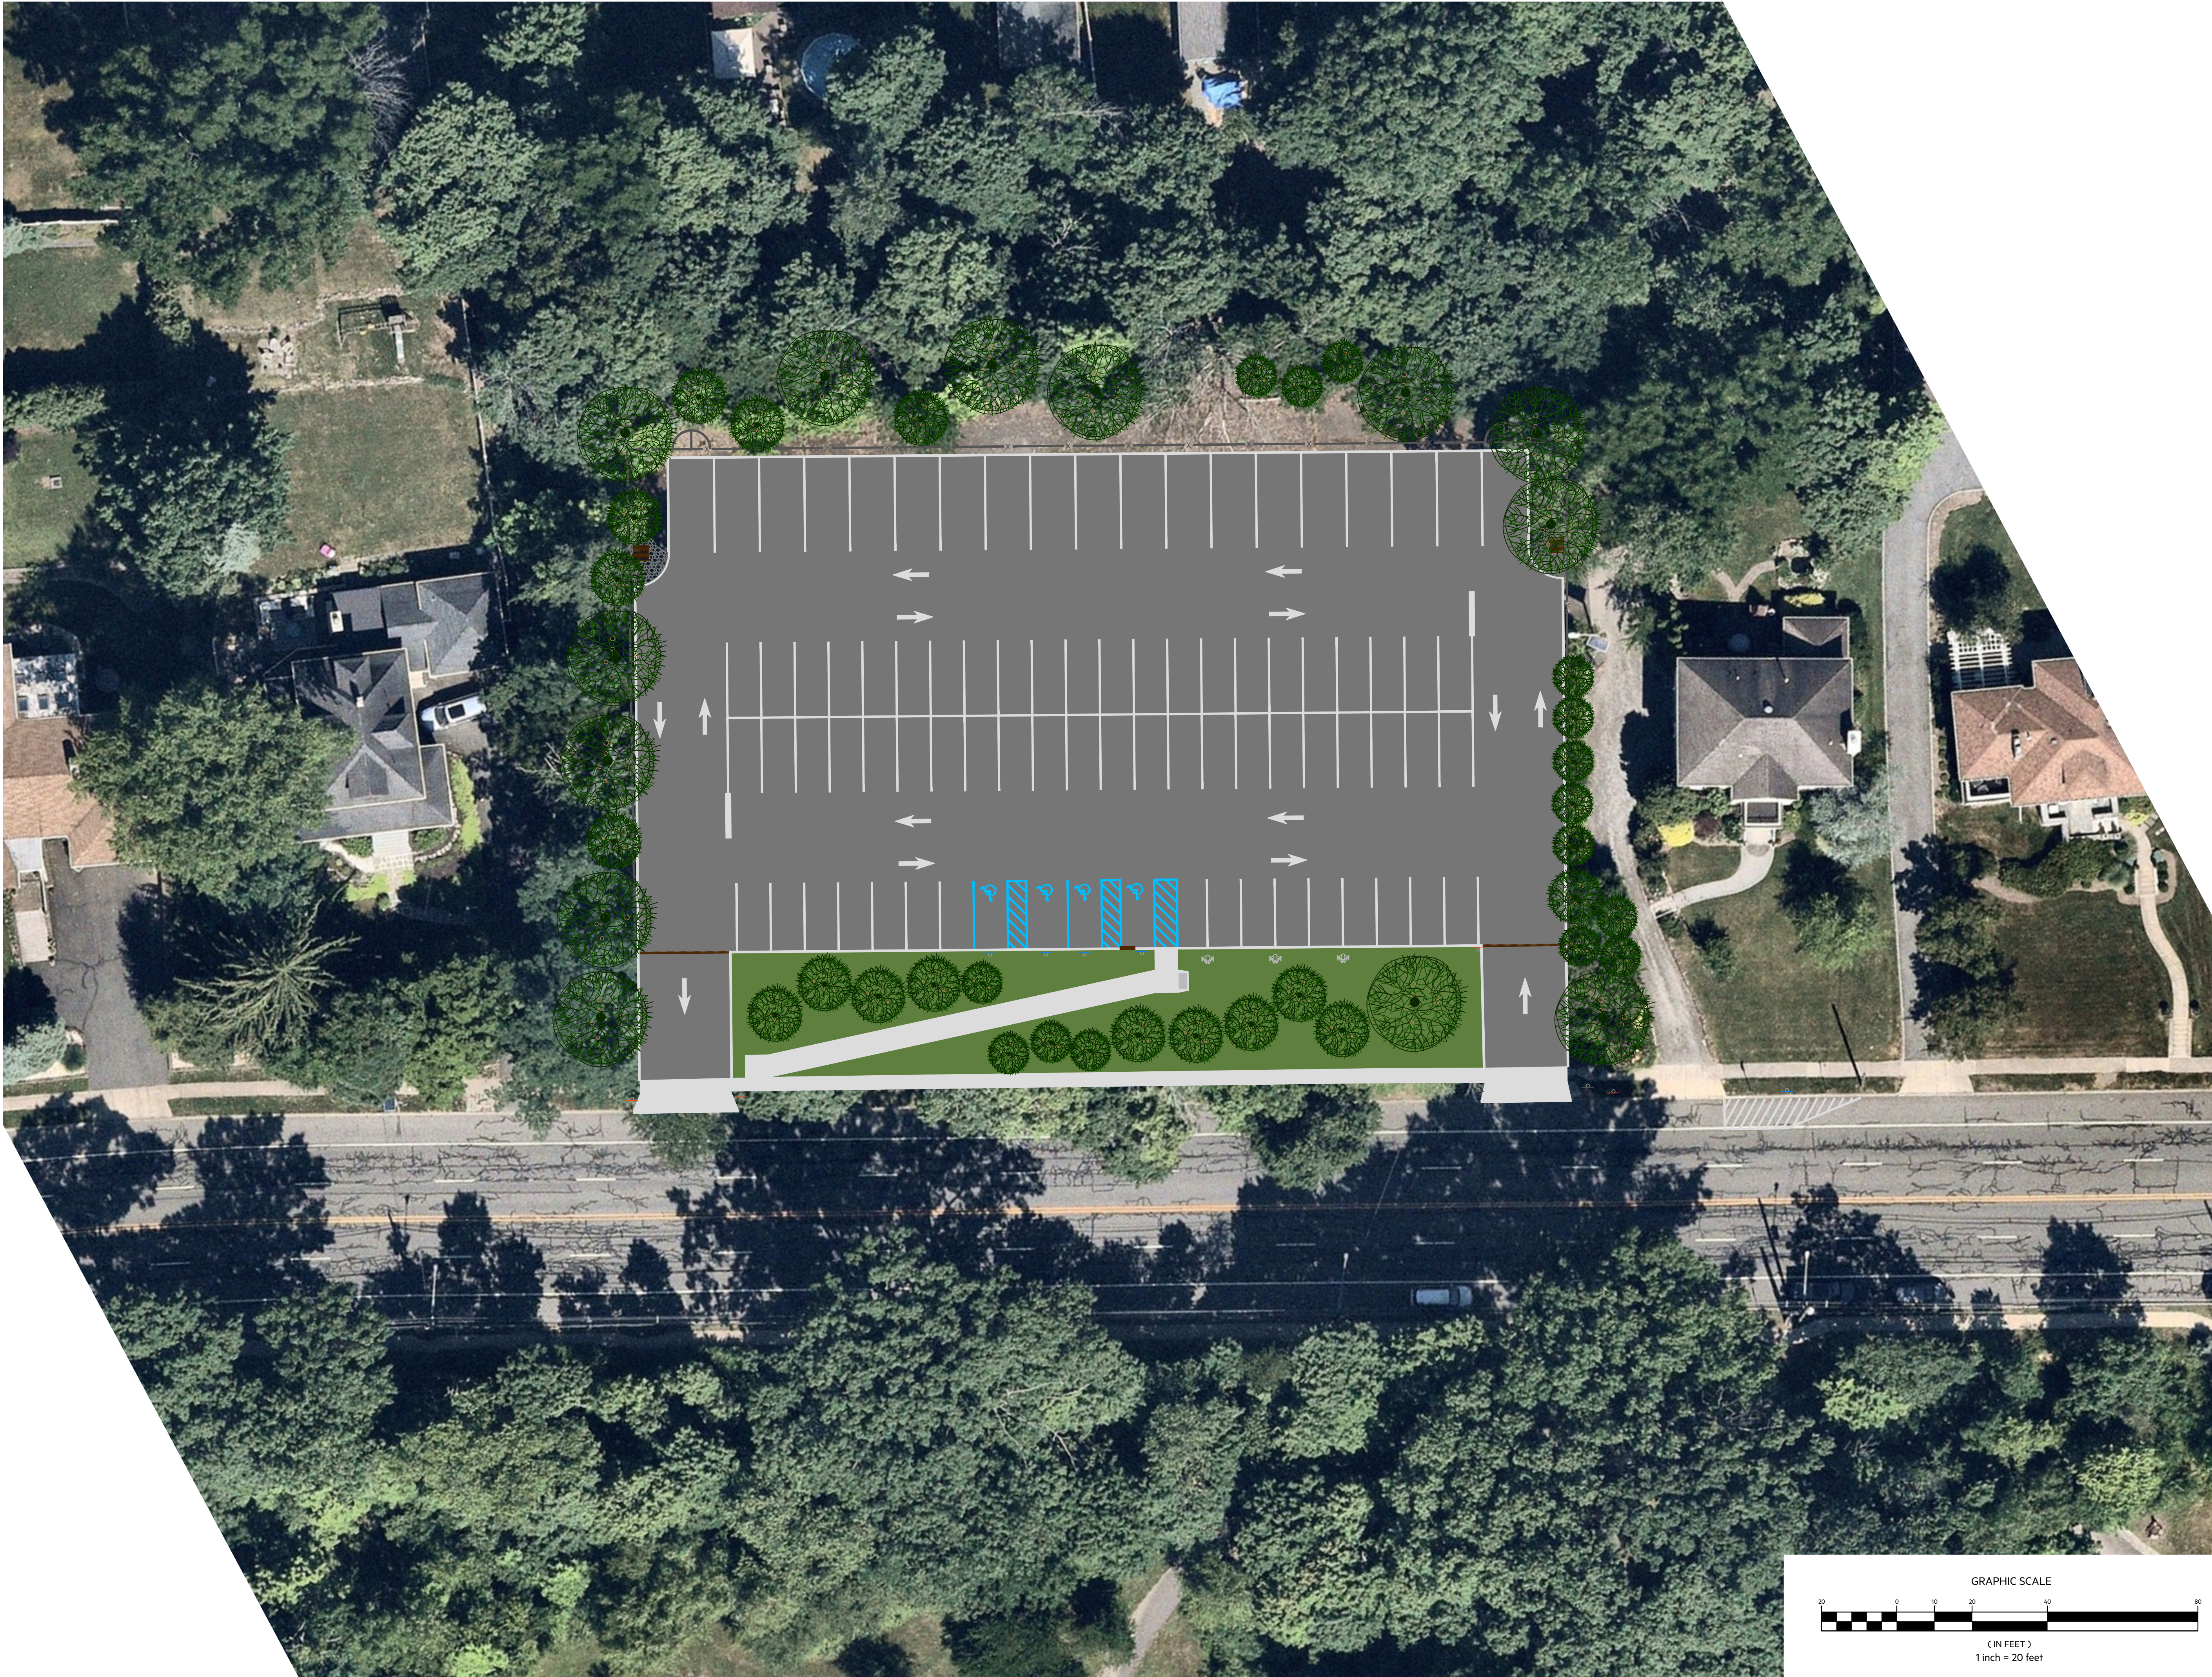
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609 466 0002
ALBANY, NY 12204
518 436 6380
POCONOKEE, NY 18343
914 682 5900
N.J. CERTIFICATE OF AUTHORIZATION No. 24GA27958000

LADY OF THE LAKE PARKING LOT
IMPROVEMENT PROJECT

SITE PLAN RENDERING

SURVEYED BY:	DESIGNED BY:	DATE:	JOB NO.:
N/A	N/A	6/13/25	VA171
DRAWN BY:	CHECKED BY:	SCALE:	SHEET:
KEM	JSK	1"=20'	1 OF 1

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